

1993 NORTHEASTERN MT COAL MAINTENANCE PROJECT

DSL - AMRB No. 93-M03

FINAL REPORT

Several Counties in Northeast Montana



November 26th, 1993

SPECTRUM ENGINEERING

Billings, Montana

FINAL REPORT

**1993 NORTHEASTERN MT COAL
MAINTENANCE PROJECT**

DSL - AMRB No. 93-M03



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FINAL REPORT

1993 NORTHEASTERN MT COAL MAINTENANCE PROJECT

DSL - AMRB No. 93-M03

Sites Located in Northeastern Montana

**Black Diamond North Mine
North Wibaux
Mullendore
Johnson Hill
Schmidt Site
Ahren
Seven Sisters
Canyon Creek
Bemer
Antelope II
Meyer
Raymond
Nikolaisen
Whitetail Creek
Nay-Butler**

November 26th, 1993

**Spectrum Engineering
1413 4th Avenue North
Billings, MT 59101**

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1993 NORTHEASTERN MT COAL MAINTENANCE PROJECT

1. INTRODUCTION

1.1 Project Description

The 1993 Northeastern MT Coal Maintenance Project consists of 15 project sites located in northeastern Montana from Wibaux in the southeastern part of Montana to Plentywood in the northeastern part of Montana. These sites are found in Wibaux, Dawson, Richland, Sheridan and Daniels Counties. All of these sites were previously reclaimed under the abandoned mine program and had failed in one way or another. The need for this project was to protect human health and safety caused by subsidence and dangerous openings.

The work consisted of salvaging and replacing topsoil; closing mine adits and shafts; backfilling subsidence; regrading erosional areas; neutralizing coal slack; and revegetating disturbed areas. The Contractor was also required to secure a MPDES Storm Water Discharge Permit to cover all sites.

1.1.1 Location and Access

Black Diamond North Mine Site.

The Black Diamond North Mine Site is located in the SE $\frac{1}{4}$ Section 10, T13N, R60E in Wibaux County. The latitude is 46° 53.58' and the longitude is 104° 06.38'. The site is found on the 7 $\frac{1}{2}$ minute USGS quadrangle named Beach West.

The site is situated about 7.5 miles southeast of the town of Wibaux. Access is by proceeding south from Wibaux on State Highway 7 (FAP 27) for approximately 4.2 miles. Turn left and head east on a graveled county road for 4.5 miles, then turn right (south) onto a dirt and gravel road. The mine site is 1.5 miles along this road, on the right (west) side.

North Wibaux Site.

The North Wibaux Site is located in the SE $\frac{1}{4}$ NE $\frac{1}{4}$ Section 13, T15N, R59E in Wibaux County. The latitude is 47° 03.32' and the longitude is 104° 10.62'. The site is found on the 7 $\frac{1}{2}$ minute USGS quadrangle named Odland Dam SW.

The site is approximately 5 miles due north of the town of Wibaux. Drive north from Wibaux on paved Highway FAS 261 for a distance of 4 miles until you reach Mile Post 4. Approximately $\frac{1}{4}$ mile past M.P. 4 turn right off the paved highway onto a gravel road and head east for 0.6 miles. Turn left (north) and proceed about $\frac{1}{4}$ mile to a gate on the left (west) side of the road. Follow an access trail a short distance to the mine site.

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Mullendore Site.

The Mullendore Site is located in the NE $\frac{1}{4}$ SW $\frac{1}{4}$ Section 30, T16N, R57E in Dawson County. The latitude is 47° 06.81' and the longitude is 104° 33.13'. The site is found on the 7 ½ minute USGS quadrangle named Allard.

It is approximately 7 miles east of Glendive. Access is by taking Interstate 94 east out of Glendive and traveling about 8 miles to the Griffith Creek Exit. Exit Interstate 94 and travel back to the west along the frontage road for approximately 1½ miles (crossing a flowing stream) before the road turns right (north) away from the Interstate. Follow this access road as it travels along Griffith Creek for approximately 1¼ miles. The road goes through 2 gates and comes to a stock pond and Area #1. Area No. 2 is accessible by a secondary road turning right and crossing the stock dam and proceeding up the hill.

Johnson Hill Site.

The Johnson Hill Site is located in the SE $\frac{1}{4}$ NE $\frac{1}{4}$ Section 31, T20N, R54E in Dawson County. The latitude is 47° 26.91' and the longitude is 104° 52.50'. The site is found on the 7 ½ minute USGS quadrangles named Bloomfield and Red Top.

It is approximately 25 miles north-northwest of Glendive. The site can be reached by traveling north from Glendive on paved Highway FAS 254 for 26 miles to the town of Bloomfield, and continuing north on FAS 254 past Bloomfield for 4 more miles. At this point turn right (east) off the paved road onto a graveled road for a distance of two miles. Turn right (south) again and travel 1½ miles further to the site.

Schmidt Site.

The Schmidt Site is located in the SW $\frac{1}{4}$ NW $\frac{1}{4}$ Section 34, T21N, R54E in Dawson County. The latitude is 47° 31.75' and the longitude is 104° 54.42'. The site is found on the 7 ½ minute USGS quadrangle named Clay Buttes.

It lies about 10½ miles to the southeast of Richey. Richey is between the towns of Circle and Sidney on State Highway 200. Access to the Schmidt Site is by proceeding southeast out of Richey on paved Highway FAS 254 for 11 miles. The site is about 400 feet on the left (east) side of the road.

Ahren Site.

The Ahren Site is located in the NW $\frac{1}{4}$ NW $\frac{1}{4}$ Section 26 and the NE $\frac{1}{4}$ NE $\frac{1}{4}$ Section 27, T23N, R53E in Richland County. The latitude is 47° 43.86' and the longitude is 104° 53.54'. The site is found on the 7 ½ minute USGS quadrangle named Kuester Lake.

Background

The main body of the report is divided into two parts. The first part, "Background," provides a general overview of the situation in the United States and the world. The second part, "Findings," presents the results of the investigation.

The report is organized into several chapters. Chapter 1, "Introduction," discusses the purpose and scope of the investigation. Chapter 2, "Background," provides a general overview of the situation in the United States and the world. Chapter 3, "Findings," presents the results of the investigation. Chapter 4, "Conclusions," discusses the implications of the findings. Chapter 5, "Recommendations," provides suggestions for improving the situation.

Findings

The findings of the investigation are presented in Chapter 3. The report identifies several areas of concern, including the lack of transparency in government operations, the need for greater accountability, and the importance of public participation in decision-making.

The report also identifies several areas of strength, including the commitment of the government to the rule of law, the effectiveness of the judicial system, and the active role of the media in monitoring government activities.

Conclusions

The conclusions of the investigation are presented in Chapter 4. The report concludes that the situation in the United States and the world is complex and requires a comprehensive approach to address the challenges facing society.

The report also concludes that the government has a responsibility to ensure that its actions are in the best interests of the people and that it is held accountable for its actions.

The report provides a detailed analysis of the issues and offers a range of recommendations for improving the situation. The report is a valuable resource for anyone interested in the current state of the world and the role of government in society.

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It is between Richey and Lambert along Redwater Creek. Access is from State Highway 200, 9½ miles east of Richey and approximately 4 miles west of Enid. Turn off Highway 200 onto a graveled road and travel north for just over ½ mile to a fork in the road. Turn left (west) and go approximately 1 ¾ miles to a trail on the right side of the road. Follow this trail north about ½ mile to the site. You will cross Redwater Creek about 200 yards before the site.

Seven Sisters Site.

The Seven Sisters Site is located in the NW¼SW¼ Section 21, T21N, R58E in Richland County. The latitude is 47° 33.81' and the longitude is 104° 17.47'. The site is found on the 7 ½ minute USGS quadrangle named Crane.

It is 12 miles southwest of Sidney, just west of Highway 16 between Glendive and Sidney. Access is by proceeding southwest on State Highway 16 for 12 miles to a turnoff approximately one mile south of Crane. Turn right off the highway and follow a road west approximately ½ mile across the main canal and then along a trail about ¼ mile to the mine site.

Canyon Creek Site.

The Canyon Creek Site is located in the NW¼SW¼ Section 17, T21N, R59E in Richland County. The latitude is 47° 34.70' and the longitude is 104° 11.21'. The site is found on the 7 ½ minute USGS quadrangle named Piche.

It is situated 9½ miles south of Sidney, 3½ miles east of Crane. Access is by taking State Highway 23 east out of Sidney for 2½ miles to the junction of Highway FAS 261. Turn right onto FAS 261 and travel south 3½ miles. Turn right onto a gravel road which will take you west one mile, south one mile, west again for one mile, south again for one mile, and at a corner where the main road again turns to the west, leave this road and turn south onto a dirt road. Travel a little over ½ mile to the mine site.

Bemer Site.

The Bemer Site is located in the S½ Section 18, T27N, R56E in Richland County. The latitude is 48° 05.50' and the longitude is 104° 32.10'. The site is found on the 7 ½ minute USGS quadrangle named Dugout Creek.

It is south of the town of Culbertson about 3½ miles. The Bemer Mine Site can be reached by taking State Highway 16 south of Culbertson for about 4 miles. Turn right off the highway onto a county road and travel west 2 ¾ miles. The mine access road turns left (south) from the county road and takes you one mile to the mine site.

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Antelope II Site.

The Antelope II Site is located in the SE $\frac{1}{4}$ SE $\frac{1}{4}$ Section 16, T34N, R55E in Sheridan County. The latitude is 48° 41.60' and the longitude is 104° 31.00'. The site is found on the 7 $\frac{1}{2}$ minute USGS quadrangle named Shippe Canyon.

It is situated 5 $\frac{1}{2}$ miles south-southeast of Plentywood. Take State Highway 16 south out of Plentywood for just over 5 $\frac{1}{2}$ miles. Turn right onto a county road and travel west for 1 $\frac{1}{2}$ miles where the road turns and heads southwest. Continue for 1 $\frac{1}{2}$ miles more, and the mine site can be found just to the right (north) of the road.

Meyer Site.

The Meyer Site is located in the NE $\frac{1}{4}$ Section 5, T35N, R58E in Sheridan County. The latitude is 48° 49.30' and the longitude is 104° 08.95'. The site is found on the 7 $\frac{1}{2}$ minute USGS quadrangle named Tadpole Lake.

It lies 6 miles southwest of Westby, which is on the Montana/North Dakota state line. After traveling 4 miles west on State Highway 5 from Westby, turn left (south) onto a graveled county road. Go 2 $\frac{1}{4}$ miles, then turn right (west) and follow the road for just over $\frac{1}{4}$ mile. Turn left and go south on an oil well access road for $\frac{1}{8}$ mile to mine site.

Raymond Site.

The Raymond Site is located in the W $\frac{1}{2}$ Section 6, T36N, R55E in Sheridan County. The latitude is 48° 53.80' and the longitude is 104° 34.40'. The site is found on the 7 $\frac{1}{2}$ minute USGS quadrangle named Raymond.

It is situated 2 miles north of the town of Raymond and 6 $\frac{1}{2}$ miles south of the Canadian border just east of State Highway 16. Drive north out of Raymond for 2 miles and the site is accessible across a plowed field. The site is $\frac{3}{4}$ mile north of the owners house.

Nikolaisen Site.

The Nikolaisen Site is located in the SE $\frac{1}{4}$ SW $\frac{1}{4}$ Section 10, T35N, R55E in Sheridan County. The latitude is 48° 47.76' and the longitude is 104° 30.40'. The site is found on the 7 $\frac{1}{2}$ minute USGS quadrangle named Plentywood.

It is situated 2 $\frac{1}{2}$ miles northeast of Plentywood. Drive northeast out of Plentywood toward the Sher-Wood Airport. Proceed past the airport turnoff and travel north for $\frac{1}{2}$ mile, and then proceed east $\frac{3}{4}$ mile until the road turns north. Leave the main road and continue east-northeast for $\frac{1}{2}$ mile to the project site.

APPENDIX A

The following table is based on the 1952 Census of the U.S. and is intended to provide a general picture of the coal mining industry in the U.S. in 1952.

It is estimated that the coal mining industry in the U.S. in 1952 employed approximately 1,000,000 men and women. The industry is divided into two main branches, bituminous coal and anthracite coal.

Table A-1

The following table shows the production of coal in the U.S. in 1952, by state and by type of coal.

It is estimated that the total production of coal in the U.S. in 1952 was approximately 1,000,000,000 tons. The production of bituminous coal was approximately 800,000,000 tons, and the production of anthracite coal was approximately 200,000,000 tons.

Table A-2

The following table shows the consumption of coal in the U.S. in 1952, by state and by type of coal.

It is estimated that the total consumption of coal in the U.S. in 1952 was approximately 1,000,000,000 tons. The consumption of bituminous coal was approximately 800,000,000 tons, and the consumption of anthracite coal was approximately 200,000,000 tons.

The following table shows the export and import of coal in the U.S. in 1952.

It is estimated that the U.S. exported approximately 100,000,000 tons of coal in 1952, and imported approximately 100,000,000 tons of coal in 1952.

The following table shows the production of coal in the U.S. in 1952, by type of coal.

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Whitetail Creek Site.

The Whitetail Creek Site is located in the SE¼ Section 24, T36N, R50E in Daniels County. The latitude is 48° 51.58' and the longitude is 105° 06.75'. The site is found on the 7 ½ minute USGS quadrangle named Navajo.

It is 5 miles northeast of Flaxville. Take the Highway 511 north out of Flaxville heading towards Whitetail. Proceed 3.5 miles north and then turn right and head east 3 miles. The road turns north after 3 miles. Proceed ¼ mile north and turn left (west) and proceed ¼ mile to the project site.

Nay-Butler Site.

The Nay-Butler Site is located in the SE¼SE¼ Section 20, T36N, R47E in Daniels County. The latitude is 48° 51.30' and the longitude is 105° 35.20'. The site is found on the 7 ½ minute USGS quadrangle named Four Buttes.

It is 8½ miles northeast of Scobey and 3 miles north of Four Buttes. Take Highway FAS 248 west out of Scobey for 8½ miles to Four Buttes. Turn right and proceed north on the county road for 3 miles. Turn right again and head east for approximately ¾ mile where road will turn left (north) for ¼ mile and then right. Proceed about ¼ mile and the site is on the right or south side of the road.

The reader is referred to the Site and Vicinity Maps shown on the Site Plan sheets for further description of the access to the sites. No 8 ½ x 11 inch site access maps were prepared for these sites.

1.1.2 Land Ownership

The land ownership is shown in the following table from Section I of the bid package.

<u>SITE NAME</u>	<u>LOCATION</u>	<u>LANDOWNER/CONTACT</u>
<u>WIBAUX COUNTY</u>		
Black Diamond North Mine	NE¼SE¼ Section 10, T13N, R60E	Earl Smith Rural Route 198 Wibaux, MT 59353 406-795-2554
North Wibaux Site	SE¼NE¼ Section 13, T15N, R59E	Mrs. Lanny Peters 708 1st Avenue South Wibaux, MT 59353 406-795-8119

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DAWSON COUNTY

Mullendore	NE $\frac{1}{4}$ SW $\frac{1}{4}$ Section 30, T16N, R57E	Donald D. Mullendore 323 Clough St. Glendive, MT 59330 406-365-5314
Johnson Hill Site	SE $\frac{1}{4}$ NE $\frac{1}{4}$ Section 31, T20N, R54E	Lloyd & Kathryn Hostetler 522 Road 524 Bloomfield, MT 59315 406-583-7758
Schmidt Site	SW $\frac{1}{4}$ NW $\frac{1}{4}$ Section 34, T21N, R54E	Warren Schwartz Box 1002 Wolf Point, MT 59201 406-653-1168

RICHLAND COUNTY

Seven Sisters	NW $\frac{1}{4}$ SW $\frac{1}{4}$ Section 21, T21N, R58E	Ed Clemmer Rural Route Crane, MT 59217
Ahren Mine	NW $\frac{1}{4}$ NW $\frac{1}{4}$ Section 26, T23N, R53E	Rhines Farming Corp. Harold Rhines P.O. Box 19 Sidney, MT 59270 406-774-3465 or 482-3750
	NE $\frac{1}{4}$ NE $\frac{1}{4}$ Section 27, T23N, R53E	Tim Bouchard Route 2, Box 2366 Sidney, MT 59270 406-482-4125
Canyon Creek Site	NW $\frac{1}{4}$ SW $\frac{1}{4}$ Section 17, T21N, R59E	Tod V. & Susan L. Gorder Box 4054 Skaar Route Sidney, MT 59270 406-482-2254
Bemer Site	NE $\frac{1}{4}$ NE $\frac{1}{4}$ SW $\frac{1}{4}$ Section 18, T27N, R56E	Howard & Julie Bemer (NE $\frac{1}{4}$ SW $\frac{1}{4}$, Section 18) Box 1596 Poplar, MT 59255 406-768-3601

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SHERIDAN COUNTY

Antelope II Site	SE $\frac{1}{4}$ SE $\frac{1}{4}$ Section 16, T34N, R55E	State of Montana Department of State Lands Attn: Jeff Hagener 1625 11th Avenue Helena, MT 59620 406-444-2074 James Cybulski (Lessee) RR 1, Box 1130 Plentywood, MT 59254 406-286-5615
Meyer Mine	NW $\frac{1}{4}$ NE $\frac{1}{4}$ Section 5, T35N, R58E	John & Marilyn Shoal Box 235 Columbia Falls, MT 59912 Donald Shoal (Contact) 518 Glenwood Plentywood, MT 59254 406-765-1475
Raymond Mine	SW $\frac{1}{4}$ NW $\frac{1}{4}$ Section 6, T36N, R55E	Myrlen Paulson Box 122 Raymond, MT 59256 406-895-2523
Nikolaisen Site	SE $\frac{1}{4}$ SW $\frac{1}{4}$ Section 10, T35N, R55E	Maretta Ramirez 7508 E. McKnight Scottsdale, AZ 85251 Unlisted Phone Number Lucille C. King Stewart 15 Ash Drive Wayburn, Sask. S4H0R9 306-842-8141

1993 NORTHEASTERN MT COAL MAINTENANCE PROJECT

DANIELS COUNTY

Whitetail Creek Site	W $\frac{1}{2}$ SE $\frac{1}{4}$ Section 24, T36N, R50E	Mr. Larry Meyers (S $\frac{1}{2}$ SE $\frac{1}{4}$ & NW $\frac{1}{4}$ SE $\frac{1}{4}$) Rural Route 1 Flaxville, MT 59222 406-779-3637
Nay-Butler Site	SE $\frac{1}{4}$ SE $\frac{1}{4}$ Section 20, T36N, R47E	Tade Inc. Marvin Tade-President Rural Route Scobey, MT 59263 406-783-5514

1.1.3 History

The history (if any existed) on each of these projects is found with the original bid packages and final reports for these projects. No history is repeated herein.

1.2 Project Objectives/Site Problems

This project was needed to protect health and safety caused by subsidence holes and dangerous openings which have reopened since the original AMRB work at each site was completed. The site problems are described below:

1.2.1 Black Diamond North Mine

Two subsidence holes (17' x 8' x 6' and 7' x 7 $\frac{1}{2}$ x 2') require backfilling with adjacent borrow material. All disturbed areas will be revegetated.

1.2.2 North Wibaux

Two subsidence holes (11' x 13' x 5'd and 14' x 17' x 5'd) require backfilling with borrow from the coal slack pile. Then the backfilled subsidence holes and coal slack area are to be neutralized with lime. The cover soil will be respread over the subsidence holes and borrow area to a depth of 3 inches. All disturbed areas will be revegetated.

1.2.3 Mullendore

Thirteen 13 subsidence holes need to be backfilled with borrow from the designated borrow area. Prior to the backfill operation, 6 inches of cover soil will be salvaged and temporarily stockpiled from the borrow area. After sufficient borrow has been secured, the borrow area will be retopsoiled. Then all backfilled areas, the borrow area and all other disturbed areas will be graded and fertilized, seeded and mulched.

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BARBARA COUNTY

Location	Project	Notes
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Barbara County	Coal Maintenance	Project 1992
Barbara County	Coal Maintenance	Project 1992
Barbara County	Coal Maintenance	Project 1992
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Barbara County	Coal Maintenance	Project 1992
Barbara County	Coal Maintenance	Project 1992
Barbara County	Coal Maintenance	Project 1992

1993

The history of the project is as follows: The project was initiated in 1992 and has been ongoing since that time. The project is a coal maintenance project and is located in Barbara County. The project is a coal maintenance project and is located in Barbara County. The project is a coal maintenance project and is located in Barbara County.

1994

The project was initiated in 1992 and has been ongoing since that time. The project is a coal maintenance project and is located in Barbara County. The project is a coal maintenance project and is located in Barbara County. The project is a coal maintenance project and is located in Barbara County.

1995

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1996

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1997

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1998

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1999

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1.2.4 Johnson Hill

The goal is to repair some erosional channels, neutralize and cover coal slack areas with topsoil, and revegetate.

Two coal slack areas (150' x 150' and 50' x 120') will be neutralized with lime. The coal slack areas will then be covered with 3 inches of topsoil from the borrow area. The borrow area, coal slack areas and erosional channel regrade areas will then be revegetated.

1.2.5 Schmidt

A subsided airshaft requires backfilling. The hole is 7' x 11' x 4'd with a smaller 1' x 2' hole in the bottom. Adjacent borrow material will be used as fill. All disturbed areas will be revegetated.

1.2.6 Ahren

Adjacent borrow material will be used to backfill four subsidence holes (6' x 4' x 4'd, 3' x 3' x 8'd, 5' x 6' x 4'd, and 6' x 8' x 10'd). The disturbed areas (borrow area, backfilled subsidence holes and all other disturbance) will be revegetated.

1.2.7 Seven Sisters

The work is to collapse a roof over an inclined opening, backfill the remaining hole, and then revegetate.

First, the Contractor will develop an access route as necessary to access the inclined opening. The work is to collapse the roof over the opening for a distance of 15 feet, then backfill the hole with borrow from the coal slack area. Both the backfilled area and the coal slack borrow area will be neutralized with lime. Then revegetate the borrow area, access route, backfilled area, and all other disturbed areas.

1.2.8 Canyon Creek

Three subsidence holes (12' x 14' x 7'd, 5' x 8' x 5'd, 5' x 3' x 5'd plus undercuts) require backfilling with adjacent borrow material. All disturbed areas will be revegetated.

1.2.9 Bemer

One mine adit (4' x 10' x 30'+ long) has reopened and will be backfilled with adjacent borrow material. The backfilled adit, borrow area and other disturbed areas will be revegetated.

1992 TO 2000: THE COAL INDUSTRY PROJECT

1.1. Introduction

The aim of this project is to provide a comprehensive overview of the coal industry in the United Kingdom, covering the period from 1992 to 2000. The project is divided into several sections, each focusing on a different aspect of the industry.

The first section, 'The Coal Industry in the United Kingdom', provides a general overview of the industry, including its history, its current status, and its future prospects. This section also discusses the role of the coal industry in the UK economy and the environment.

1.2. The Coal Industry in the United Kingdom

A detailed overview of the coal industry in the United Kingdom, covering the period from 1992 to 2000. This section discusses the role of the coal industry in the UK economy and the environment.

1.3. The Coal Industry in the United Kingdom

A detailed overview of the coal industry in the United Kingdom, covering the period from 1992 to 2000. This section discusses the role of the coal industry in the UK economy and the environment.

1.4. The Coal Industry in the United Kingdom

The coal industry in the United Kingdom has been a major source of employment and income for many years. It has also been a major source of energy for the country.

1.5. The Coal Industry in the United Kingdom

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1.6. The Coal Industry in the United Kingdom

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1.2.10 Antelope II

The work includes regrading numerous erosional channels (60' x 1' x 0.5'd) and repair of the diversion ditch as necessary. Then all disturbed areas will be revegetated.

1.2.11 Meyer

The work includes stripping and stockpiling topsoil from the borrow area (20 foot radius around the subsidence hole), grading 6 inches of material into the subsidence hole (13' x 19' x 3'd) from the borrow area, and then replacing the topsoil evenly over the entire area. All disturbed areas (backfilled subsidence hole and borrow area) will be revegetated.

1.2.12 Raymond

The goal is to determine if an airshaft needs to be backfilled, fill it with boulders and dirt, and stockpile boulders on site.

The Contractor will excavate the air shaft (10' x 21' area) to a depth of 8 feet to determine if further work is required. If the air shaft is already backfilled, then refill the bottom 4 feet with adjacent boulders and top 4 feet with dirt. Spread remaining cover soil in low surrounding areas. Remaining rock piles scattered throughout the unplowed mine area will be load-haul-dumped to a central stockpile. The backfilled air shaft will be revegetated.

A new subsidence hole was found when the earthwork contractor arrived on-site. This hole was also backfilled.

1.2.13 Nikolaisen

Two coal slack piles (30' x 150' and 25' x 60') will be neutralized with lime. Then borrow (3 inches of topsoil) will be placed over the neutralized coal slack areas. All disturbed areas will be revegetated.

1.2.14 Whitetail Creek

There is a subsidence hole (with dimensions of 7'-14' wide by 23' long by 4'-8' deep) in the creek bottom to backfill and revegetate. Adjacent borrow material will be used as fill. The backfilled subsidence hole and borrow areas will be revegetated. Ten straw bales will be placed as shown on the plan sheet for erosion control.

1993 NORTHEASTERN MT COAL MAINTENANCE PROJECT

1.2.15 Nay-Butler

The work is to backfill three subsidence areas consisting of a subsidence trench (9' x 13' x 7'd), and two small subsidence holes with adjacent borrow material. The backfilled subsidence areas, borrow area and all other disturbed areas will be revegetated.

2. RESPONSIBLE PARTIES

2.1 Contractor

The successful low bidder was Hallett Reclamation. Their address is shown below:

Hallett Reclamation Company
P.O. Box 169
Livingston, Montana 59047
Phone: 406/222-1446
MT Contractor's License: 7789 A

2.2 Reclamation and Engineering Plan

Spectrum Engineering was assigned the responsibility of preparing the reclamation and engineering specifications prior to contractor selection. Plans conforming to the general requirements were formulated in the field to meet specific conditions.

Spectrum's address is shown below:

Spectrum Engineering
1413 4th Avenue North
Billings, Montana 59101
Phone: 406/259-2412

2.3 Quality Control Inspection

Spectrum Engineering performed the quality control inspection. The project engineer was Bill Maehl and the construction inspector was Hank Lowe.

2.4 AMRB Coordination

The AMRB Project Manager was Joel Chavez, Montana Department of State Lands, Abandoned Mine Reclamation Bureau.

1993 NORTHEASTERN MT COAL MAINTENANCE PROJECT

3. CHRONOLOGICAL LISTING OF EVENTS

3.1 Pre-Bid Conference

The pre-bid conference was held on July 20th, 1993 at the courthouse in Glendive.

3.2 Bid Date

The bid opening date was July 30th, 1993.

3.3 Three Lowest Bids

There were 3 bidders on this project with bids ranging from \$24,826.90 to \$60,170.00. The engineer's estimate was \$23,880.00. The bid tabulations have been included in ATTACHMENT 1. The three bidders are listed below.

Hallett Reclamation	Pine Street	Donnes Construction
Livingston, Montana	Glendive, Montana	Billings, Montana
\$ 24,826.90	\$ 26,136.00	\$ 60,170.00

3.4 Contract Award/Notice of Award/Notice to Proceed

The contract was awarded to the low bidder (Hallett Reclamation) after receiving all of their bonds, stormwater permit, and other required paper-work. The Agreement was dated August 13th, 1993.

The Notice to Proceed was issued August 13th, 1993. Hallett Reclamation performed all of the work themselves. The work started September 9th and was completed on September 26th. They used 18 of the 45 allowed calendar days to complete the work.

The prime contractors address is shown under 2.1 Contractor above.

3.5 Construction Start-up

The Contractor started mobilizing his equipment to the Black Diamond North site on September 9th, 1993.

3.6 Change Orders

There were two change orders written for this project. Copies of these change orders are included in this report as ATTACHMENT 2. The first change order was for excavating one new subsidence hole (extra Raymond site) for an additional sum of \$500.00. The second change order was for final quantities adjustments and three new subsidence holes for the sum of \$352.82. The change orders added a total of \$852.82 to the contract price.

STANDARDIZATION OF COAL MAINTENANCE PROJECT

CHRONOLOGICAL LISTING OF EVENTS

1.1 Pre-Work Conference

The project was initiated by the Coal Maintenance Project Committee. The project was initiated by the Coal Maintenance Project Committee.

1.2 Site Visit

The project was initiated by the Coal Maintenance Project Committee.

1.3 Project Planning

The project was initiated by the Coal Maintenance Project Committee. The project was initiated by the Coal Maintenance Project Committee.

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1993 NORTHEASTERN MT COAL MAINTENANCE PROJECT

3.7 Work Stoppages

There were no work shut-downs.

3.8 Requests for Payment

There was one payment request on this project. Pay Request 1 was for the period from job start through job completion (September 26th). The amount completed for this pay request was \$ 26,679.72.

3.9 Substantial Completion

The date of Substantial Completion was September 26th, 1993.

3.10 Final Completion and Approval

The AMRB field inspection date was October 4th, 1993. The Final Completion date is one year from the Substantial Completion date or September 26th, 1994.

3.11 Final Payment

Final payment was made to the Contractor on October 28th, 1993. Copies of the first (final) payment request have been included in ATTACHMENT 3.

4. CONSTRUCTION

4.1 Description of Project Plan

The objective of the proposed work is to perform maintenance work on previously reclaimed AMRB coal projects. The work at each site was minor and required about ½ to 1½ days per site to complete. More time was spent in mobilization/demobilization to each site than time spent working. None of these sites presented any construction difficulties. Several of the sites had further subsided from when the AMRB/engineer field visit occurred and when construction started. Reclamation plans were developed on-site for these extras.

3.1 Work Summary

There were no significant changes.

3.2 Requests for Payment

There was one request for payment for work performed during the period. The amount requested was \$20,000.00.

3.3 Additional Comments

The daily construction activities were as follows:

3.4 Final Completion and Approval

The final approval of this work was given by the client on 10/10/90.

3.5 Final Payment

The amount was paid to the contractor on 10/10/90.

4. CONCLUSION

4.1 Description of Work

The work was performed in accordance with the contract. The work was completed on time and within budget. The client is satisfied with the results.

1993 NORTHEASTERN MT COAL MAINTENANCE PROJECT

4.2 Major Equipment List

<u>Type</u>	<u>Make/Model</u>	<u>Size/Horsepower</u>	<u>No. on Job</u>
1993 backhoe with loader	Caterpillar 416-B	67 hp	1
1982 dump truck	Ford F-700	5 cy	1
Tractor with loader	John Deere 770	2 yd	1
Grass seeder	Brillion		1
3-Axle trailer	Bame	10 ton	1
2-Axle trailer	Smith	4 ton	1
Pickup with fuel tank	General Motors	150 gallon	1
Spring tooth	6 foot		1
Crimper	7 foot		1

4.3 Contractor Employees

The number of contractor employees on the job was 2 counting the Contractor himself.

4.4 Construction Activities

Hallett Reclamation moved their equipment to the Black Diamond North site on September 9th and began work on September 10th. Subsidence Hole B had enlarged by spring rain. It measured 16'w x 25'l x 6'd after excavation around the sandstone shelf. It was backfilled with 89 cy of borrow. Hole A was backfilled as per the site plan. After revegetation was complete, mobilized to North Wibaux site. All work done as shown on site plan. Mobilized to Mullendore site. Filled subsidence holes on east side with borrow. Borrow turned into coal seam so backfilled west side from around subsidence holes. Revegetated all disturbed areas.

Moved to Johnson Hill site next and completed as per plan sheet by repairing erosional channels and then neutralized the coal slack areas. Topsoil was spread and area was revegetated. Mobilized to Schmidt site, completed per plan sheet by backfilling and revegetating the air shaft. Mobilized to Ahren site and backfilled the subsidence holes.

Moved from there to Seven Sisters site. The mine opening was now larger than the plan sheet indicated. The hole took 156½ cubic yards to fill. Roof of mine opening was a soft sandstone and easy to break off. Neutralized coal slack area and backfilled the mine void (with coal slack). Mobilized to Canyon Creek site and backfilled 3 subsidence holes and revegetated. The larger hole had enlarged to 14' x 20' x 10' deep and required 120 cubic yards of fill. The borrow area was moved inside the fence because 100+ head of cattle was in the surrounding pasture.

Mobilized to Berner site and backfilled and revegetated the adit. Moved to Antelope II site and regraded the erosion channels and redeveloped the drainage ditch. Revegetation was completed. Mobilized to Meyer site, backfilled the subsidence hole and revegetated. Mobilized to the Nikolaisen site, neutralized the coal slack piles, covered with topsoil and revegetated.

1995 MONITORING OF COAL MAINTENANCE PROJECT

4.3. Major Equipment List

Item	Quantity	Unit Price	Total Price
1. Diesel Engine	1	10000	10000
2. Generator	1	15000	15000
3. Transformer	1	20000	20000
4. Switchgear	1	30000	30000
5. Cable	100	500	50000
6. Labor	100	100	10000
7. Material	100	50	5000
8. Transport	100	100	10000
9. Insurance	100	50	5000
10. Other	100	50	5000

4.4. Equipment Inventory

The following table shows the equipment inventory for the project.

4.5. Equipment Schedule

The following table shows the equipment schedule for the project.

4.6. Equipment Cost

The following table shows the equipment cost for the project.

4.7. Equipment Maintenance

The following table shows the equipment maintenance for the project.

4.8. Equipment Disposal

The following table shows the equipment disposal for the project.

1993 NORTHEASTERN MT COAL MAINTENANCE PROJECT

Then mobilized to the Raymond site. At the Raymond extra site (Nicklockin-John Becker's site), subsidence hole 1 was excavated to a depth of 11 feet. Some garbage and coal located. Backfilled and compacted. Landowner showed us a second subsidence hole (3' x 3' x 2½' deep) in the field where his tractor had fallen in. This hole excavated to a depth of 8 feet and then was backfilled and compacted. No revegetation was done per the landowner since it was in his plowed field. At the main Raymond site, the assumed air shaft was excavated. No evidence of air shaft found. A new subsidence or air shaft had opened up. It was 10' x 12' x 12' deep. It was filled with 40 cubic yards of boulders and 3 feet of topsoil. The scattered boulders (about 95 cubic yards worth) from the previous reclamation was stockpiled. Revegetation was then completed.

Mobilized to the Whitetail Creek site, backfilled the subsidence hole, placed the straw bales, and revegetated the subsidence and borrow area. Mobilized to the Nay-Butler site. Backfilled the 3 subsidence holes plus one extra hole. Revegetated the four subsidence holes and borrow area. This completed the Northeastern MT Coal Maintenance Project.

4.5 Quantities Used

Almost every bid item was based on a lump sum basis. This made the administration of the contract fairly straight-forward. No disputes were raised by the Contractor about the estimated quantities being wrong.

<u>Item</u>	<u>Amount</u>	<u>Unit Cost</u>
Mobilization	15. sites	\$ 473.07 / site
Provide Water	0. gallons	\$ 172.50 / 1000 gallons
Salvage and Replace Cover Soil	105. yards	\$ 6.33 / yard
Close Mine Openings (110 CY)	2. each	\$ 462.50 / each
Subsidence Backfilling	470. yards	\$ 7.97 / yard
Erosion Grading	20. yards	\$ 98.50 / yard
Excavate Air Shaft	1. each	\$ 1190.00 / each
Neutralize Coal Slack Areas	1.13 acres	\$ 2600.00 / acre
Straw Bales for Erosion Control	10. bales	\$ 9.00 / bale
Fertilize, Seed & Mulch	2.93 acres	\$ 1530.00 / acre

5. PAYMENT REQUESTS

5.1 Pay Request

One pay requests was processed for this project as addressed under Section 3.10 above. A copy of this pay request has been included in ATTACHMENT 3.

1988 NORTHWESTERN SIT COAL MAINTENANCE REPORT

This document is the first of a series of reports that will be prepared by the Northwest Sit Coal Maintenance Committee. The purpose of this report is to provide a summary of the work that has been done during the past year. The report is divided into two main sections: a description of the work that has been done and a list of the recommendations that have been made. The first section describes the work that has been done in the areas of maintenance, safety, and health. The second section lists the recommendations that have been made for the future. The report is intended to provide a summary of the work that has been done and to provide a basis for the development of a long-term maintenance plan.

The work that has been done during the past year has been in the areas of maintenance, safety, and health. The maintenance work has been done in the areas of the mine, the mill, and the power plant. The safety work has been done in the areas of the mine, the mill, and the power plant. The health work has been done in the areas of the mine, the mill, and the power plant. The recommendations that have been made for the future are in the areas of maintenance, safety, and health.

2.1. Maintenance

The maintenance work that has been done during the past year has been in the areas of the mine, the mill, and the power plant. The maintenance work has been done in the areas of the mine, the mill, and the power plant. The maintenance work has been done in the areas of the mine, the mill, and the power plant.

2.2. Safety

The safety work that has been done during the past year has been in the areas of the mine, the mill, and the power plant. The safety work has been done in the areas of the mine, the mill, and the power plant. The safety work has been done in the areas of the mine, the mill, and the power plant.

2.3. Health

The health work that has been done during the past year has been in the areas of the mine, the mill, and the power plant. The health work has been done in the areas of the mine, the mill, and the power plant. The health work has been done in the areas of the mine, the mill, and the power plant.

2.4. Recommendations

The recommendations that have been made for the future are in the areas of maintenance, safety, and health. The recommendations that have been made for the future are in the areas of maintenance, safety, and health. The recommendations that have been made for the future are in the areas of maintenance, safety, and health.

1993 NORTHEASTERN MT COAL MAINTENANCE PROJECT

5.2 Cost per Site

<u>Site Name</u>	<u>Disturbed Acres</u>	<u>Cost/Acre</u>	<u>Total Project Cost</u>
Black Diamond North	0.10	\$ 29,305.20	\$ 2,930.52
North Wibaux	0.20	13,015.00	2,603.00
Mullendore	0.10	16,180.00	1,618.00
Johnson Hill	0.80	5,692.50	4,554.00
Schmidt	0.02	14,030.00	280.60
Ahren	0.20	3,755.00	751.00
Seven Sisters	0.30	9,703.33	2,911.00
Canyon Creek	0.20	5,785.00	1,157.00
Berner	0.20	4,480.00	896.00
Antelope II	0.20	6,355.00	1,271.00
Meyer	0.10	5,130.00	513.00
Raymond	0.01	260,290.00	2,602.90
Nikolaisen	0.20	4,575.00	855.00
Whitetail Creek	0.20	4,560.00	912.00
Nay-Butler	<u>0.10</u>	<u>18,247.00</u>	<u>1,824.70</u>
Total	2.93	\$ 8,764.41	\$ 25,679.72

5.3 Total Project Cost

The original bid was \$24,826.90 and two change orders were issued for \$852.82 (\$500.00 + \$352.82) bringing the total construction cost to \$25,679.72. The total engineering cost for the project was \$ 38,893.82. An analysis of the engineering costs versus construction costs is presented in ATTACHMENT 4.

6. PROJECT SUMMARY

6.1 Summary of Project

The project went as scheduled with few modifications. The only changes necessary were due to additional subsidence which had occurred from the time the bid package was prepared and the construction started.

Hallett Reclamation completed the project in the allowable contract time using 18 of the 45 days available.

1993 NORTHEASTERN MT COAL MAINTENANCE PROJECT

6.2 Site Condition after Completion

All work looked good and followed specifications. Hallett Reclamation, the Contractor, did a good job on this small project.

6.3 Maintenance or Follow-up

The Nay-Butler and Raymond sites exhibited active subsidence (new holes opened up from when the engineer was shown the sites and when construction started). These sites and Berner should be checked next spring for further subsidence or adit opening.

6.4 Bid Package (Construction) Drawings

The bid package contained seventeen Site Plan sheets covering the work at the fifteen sites. These are located in ATTACHMENT 5 at the back of the final report. These plans represent the reclamation engineering design (the plans from which the contractors bid the work).

6.5 As-Built Drawings

The original Site Plan sheets were modified to reflect as-built final reclamation construction. These are the same plans presented right before the photographs. Since each of these sites was small, there was no need to present a complete set of pre- and post-construction drawings.

7. COMMENTS/SUGGESTIONS

On this project the engineering planning went well. One site had to be dropped (Flom) because the landowner withdrew his verbal consent prior to signing the consent form after listening to a Ross Perot speech. Planning should not have proceeded without written consent. The final work product accomplished all the proposed objectives.

8. PHOTOGRAPHS/SLIDES

8.1 Listing

The description of the photographs taken to document the work performed is found at the back of the final report under ATTACHMENT 5. Each picture is numbered on the front and has a generic label on the back. Following the photo descriptions are the photos themselves. The two bound final reports contain photographs and the unbound report contains only photocopies of the photo sheets (instead of slides) per the AMRB Project Manager.

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1993 NORTHEASTERN MT COAL MAINTENANCE PROJECT

8.2 Photo Location Maps

The location where the photos were taken and their orientation are shown on the as-built plan sheets located in ATTACHMENT 5 at the back of the report.

8.3 Photos/Slides

The photographic documentation of the project includes only print film per the AMRB Project Manager.

A sequence of photographs documenting the construction activities begins immediately following the photo location maps at the back of the report.

REPORT ON THE PROGRESS OF THE WORK

1. The first part of the report is devoted to a general survey of the work done during the year.

The second part contains a detailed account of the work done in the various departments of the institution.

3. The third part of the report is devoted to a summary of the results of the work.

The fourth part contains a list of the names of the persons who have taken part in the work.

5. The fifth part of the report is devoted to a summary of the results of the work.

ATTACHMENT 1

BID TABULATIONS

ATTACHMENT 1

2011-2012

1993 Northeastern MT Coal Maintenance Project
Many Counties, MONTANA

DSL/AMRB 93-MO3
DATE July 30, 1993

BID ITEMATIONS				ENGINEER'S ESTIMATE		HALLETT RECLAMATION CO.		PINE STREET INC.		DONNES CONSTRUCTION	
Item Number	Estimated Quantity	Unit	Description	Unit Price	Total Price						
1.	1	LS	Mobilization		0.00		0.00		0.00		0.00
	1		Black Diamond North Mine		0.00	2360.00	2,360.00	1200.00	1,200.00	2900.00	2,900.00
	1		North Wibaux Site		0.00	205.00	205.00	850.00	850.00	2900.00	2,900.00
	1		Mullendore Site		0.00	240.00	240.00	1000.00	1,000.00	2900.00	2,900.00
	1		Johnson Hill Site		0.00	300.00	300.00	1000.00	1,000.00	2900.00	2,900.00
	1		Schmidt Site		0.00	170.00	170.00	650.00	650.00	2900.00	2,900.00
	1		Ahren Site		0.00	205.00	205.00	1000.00	1,000.00	2900.00	2,900.00
	1		Seven Sisters Site		0.00	355.00	355.00	1200.00	1,200.00	2900.00	2,900.00
	1		Canyon Creek Site		0.00	185.00	185.00	1000.00	1,000.00	2900.00	2,900.00
	1		Berner Site		0.00	315.00	315.00	1200.00	1,200.00	2900.00	2,900.00
	1		Antelope II Site		0.00	335.00	335.00	850.00	850.00	2900.00	2,900.00
	1		Meyer Mine		0.00	240.00	240.00	850.00	850.00	2900.00	2,900.00
	1		Raymond Mine		0.00	260.00	260.00	850.00	850.00	2900.00	2,900.00
	1		Nikolaissen Site		0.00	185.00	185.00	1100.00	1,100.00	2900.00	2,900.00
	1		Whitetail Creek Site		0.00	241.00	241.00	850.00	850.00	2900.00	2,900.00
	1		Nay-Butler Site		0.00	1500.00	1,500.00	1000.00	1,000.00	2900.00	2,900.00
	1	Inc	MPDES Storm Water Discharge Permit		0.00	0.00	0.00		0.00		0.00
2.	10	KGAL	Provide Water		0.00	172.50	1,725.00	20.00	200.00	50.00	500.00
3.	3	LS	Salvage & Replace Cover Soil		0.00		0.00		0.00		0.00
	1	LS	Mullendore Site		0.00	195.00	195.00	150.00	150.00	300.00	300.00
	1	LS	Canyon Creek Site		0.00	195.00	195.00	150.00	150.00	300.00	300.00
	1	LS	North Wibaux Site		0.00	275.00	275.00	225.00	225.00	450.00	450.00
4.	2	EA	Close Mine Openings		0.00		0.00		0.00		0.00
							9,486.00		15,325.00		45,050.00

Date		Time		Location		Description		Remarks	
10/10/2010	10:00	10:15	10:30	10:45	11:00	11:15	11:30	11:45	12:00
10/10/2010	12:00	12:15	12:30	12:45	13:00	13:15	13:30	13:45	14:00
10/10/2010	14:00	14:15	14:30	14:45	15:00	15:15	15:30	15:45	16:00
10/10/2010	16:00	16:15	16:30	16:45	17:00	17:15	17:30	17:45	18:00
10/10/2010	18:00	18:15	18:30	18:45	19:00	19:15	19:30	19:45	20:00
10/10/2010	20:00	20:15	20:30	20:45	21:00	21:15	21:30	21:45	22:00
10/10/2010	22:00	22:15	22:30	22:45	23:00	23:15	23:30	23:45	24:00
10/10/2010	24:00	24:15	24:30	24:45	25:00	25:15	25:30	25:45	26:00
10/10/2010	26:00	26:15	26:30	26:45	27:00	27:15	27:30	27:45	28:00
10/10/2010	28:00	28:15	28:30	28:45	29:00	29:15	29:30	29:45	30:00
10/10/2010	30:00	30:15	30:30	30:45	31:00	31:15	31:30	31:45	32:00
10/10/2010	32:00	32:15	32:30	32:45	33:00	33:15	33:30	33:45	34:00
10/10/2010	34:00	34:15	34:30	34:45	35:00	35:15	35:30	35:45	36:00
10/10/2010	36:00	36:15	36:30	36:45	37:00	37:15	37:30	37:45	38:00
10/10/2010	38:00	38:15	38:30	38:45	39:00	39:15	39:30	39:45	40:00
10/10/2010	40:00	40:15	40:30	40:45	41:00	41:15	41:30	41:45	42:00
10/10/2010	42:00	42:15	42:30	42:45	43:00	43:15	43:30	43:45	44:00
10/10/2010	44:00	44:15	44:30	44:45	45:00	45:15	45:30	45:45	46:00
10/10/2010	46:00	46:15	46:30	46:45	47:00	47:15	47:30	47:45	48:00
10/10/2010	48:00	48:15	48:30	48:45	49:00	49:15	49:30	49:45	50:00
10/10/2010	50:00	50:15	50:30	50:45	51:00	51:15	51:30	51:45	52:00
10/10/2010	52:00	52:15	52:30	52:45	53:00	53:15	53:30	53:45	54:00
10/10/2010	54:00	54:15	54:30	54:45	55:00	55:15	55:30	55:45	56:00
10/10/2010	56:00	56:15	56:30	56:45	57:00	57:15	57:30	57:45	58:00
10/10/2010	58:00	58:15	58:30	58:45	59:00	59:15	59:30	59:45	60:00
10/10/2010	60:00	60:15	60:30	60:45	61:00	61:15	61:30	61:45	62:00
10/10/2010	62:00	62:15	62:30	62:45	63:00	63:15	63:30	63:45	64:00
10/10/2010	64:00	64:15	64:30	64:45	65:00	65:15	65:30	65:45	66:00
10/10/2010	66:00	66:15	66:30	66:45	67:00	67:15	67:30	67:45	68:00
10/10/2010	68:00	68:15	68:30	68:45	69:00	69:15	69:30	69:45	70:00
10/10/2010	70:00	70:15	70:30	70:45	71:00	71:15	71:30	71:45	72:00
10/10/2010	72:00	72:15	72:30	72:45	73:00	73:15	73:30	73:45	74:00
10/10/2010	74:00	74:15	74:30	74:45	75:00	75:15	75:30	75:45	76:00
10/10/2010	76:00	76:15	76:30	76:45	77:00	77:15	77:30	77:45	78:00
10/10/2010	78:00	78:15	78:30	78:45	79:00	79:15	79:30	79:45	80:00
10/10/2010	80:00	80:15	80:30	80:45	81:00	81:15	81:30	81:45	82:00
10/10/2010	82:00	82:15	82:30	82:45	83:00	83:15	83:30	83:45	84:00
10/10/2010	84:00	84:15	84:30	84:45	85:00	85:15	85:30	85:45	86:00
10/10/2010	86:00	86:15	86:30	86:45	87:00	87:15	87:30	87:45	88:00
10/10/2010	88:00	88:15	88:30	88:45	89:00	89:15	89:30	89:45	90:00
10/10/2010	90:00	90:15	90:30	90:45	91:00	91:15	91:30	91:45	92:00
10/10/2010	92:00	92:15	92:30	92:45	93:00	93:15	93:30	93:45	94:00
10/10/2010	94:00	94:15	94:30	94:45	95:00	95:15	95:30	95:45	96:00
10/10/2010	96:00	96:15	96:30	96:45	97:00	97:15	97:30	97:45	98:00
10/10/2010	98:00	98:15	98:30	98:45	99:00	99:15	99:30	99:45	100:00

10/10/2010 10:00

10/10/2010 10:00

1993 Northeastern M1 Coal Maintenance Project
Many Counties, MONTANA

DSL/AMKB 93-MO3
DATE July 30, 1993

BID TABULATIONS			ENGINEER'S ESTIMATE		HALLETT RECLAMATION CO.		PINE STREET INC.		DONNES CONSTRUCTION	
Item Number	Estimated Quantity	Unit	Description	Unit Price	Total Price					
	1	EA	Seven Sisters Site		0.00	650.00	800.00	800.00	650.00	650.00
	1	EA	Berner Site		0.00	275.00	600.00	600.00	450.00	450.00
5.	9	LS	Subsidence Backfilling		0.00	0.00		0.00		0.00
	1	LS	Black Diamond N. Mine		0.00	160.00	150.00	150.00	360.00	360.00
	1	LS	North Wibaux Site		0.00	1,505.00	575.00	575.00	1,150.00	1,150.00
	1	LS	Mullendore Site		0.00	1,030.00	300.00	300.00	600.00	600.00
	1	LS	Schmidt Site		0.00	80.00	130.00	130.00	130.00	130.00
	1	LS	Abren Site		0.00	140.00	350.00	350.00	350.00	350.00
	1	LS	Canyon Creek Site		0.00	275.00	560.00	560.00	700.00	700.00
	1	LS	Meyer Mine		0.00	120.00	150.00	150.00	300.00	300.00
	1	LS	Whitetail Creek Site		0.00	275.00	350.00	350.00	700.00	700.00
	1	LS	Nay-Badler Site		0.00	160.00	350.00	350.00	410.00	410.00
6.	2	LS	Erosion Grading		0.00	0.00		0.00		0.00
	1	LS	Johnson Hill Site		0.00	1,340.00	200.00	200.00	500.00	500.00
	1	LS	Antelope II Site		0.00	630.00	350.00	350.00	500.00	500.00
7.	1	LS	Excavate Air Shaft and Stockpile Rock Piles at Raymond Site		0.00	1,190.00	800.00	800.00	0.00	0.00
8.	1.13	Acre	Neutralize Coal Slack Areas Permit		0.00	0.00		0.00		0.00
	0.12	Acre	North Wibaux Site		0.00	2,600.00	400.00	400.00	2,000.00	2,400.00
	0.65	Acre	Johnson Hill Site		0.00	2,600.00	400.00	400.00	2,000.00	1,300.00
	0.22	Acre	Seven Sisters Site		0.00	2,600.00	400.00	400.00	2,000.00	440.00
	0.14	Acre	Nikolaev Site		0.00	2,600.00	500.00	70.00	2,000.00	280.00
9.	10	EA	Straw Bales for Erosion Control at Whitetail Creek Site		0.00	9.00	15.00	150.00	20.00	200.00
10.	2.93	Acre	Fertilize, seed and Mulch		0.00	0.00		0.00		0.00
						10,858.00		6,281.00		9,260.00

HT:RECLAM:MS:PROJECT:MENT.BID

DSL/AMRB 93-MO3
DATE July 30, 1993

[illegible]

H:\RECLAM\MSP\PROJECT\NEMI.BID

ATTACHMENT 2

CHANGE ORDERS

CHANGE ORDER

ORDER NO. 1

PROJECT TITLE: 1993 Northeastern MT Coal Maintenance Project

MONT A/E or DSL-AMRB: 93-M03

CONTRACT DATE: August 13, 1993

OWNER: Department of State Lands, Abandoned Mine Reclamation Bureau

CONTRACTOR: Hallett Reclamation Company

Change Orders must be accompanied by an itemized cost breakdown. You are hereby requested to comply with the following changes from the Contract Documents. (Show separate costs for materials, labor, equipment, and miscellaneous. Show percent where applicable.)

ITEM NO.	DESCRIPTION OF CHANGES - ESTIMATED QUANTITIES & UNITS	COST OF CHANGES					TOTAL COST
		MAT'LS.	LABOR	EQUIP.	MISC.	TOTAL UNIT COST	
1.	Excavate the subsidence hole to a depth of 8 feet from ground surface to determine if further work is required. (7'x7'x6' hole-11 cy) Backfill and compact the subsidence hole assuming no further work is required. (7'x7'x8' fill-15 cy) No vegetation applied per landowner request					470.00	470.00
TOTAL COST - MATERIALS, LABOR, EQUIPMENT & MISC.							470.00
OVERHEAD & PROFIT @ <u>6.383</u> %							30.00
GRAND TOTAL - THIS CHANGE ORDER							500.00

Original Contract Price	<u>24,826.90</u>
Current Contract Price Adjusted by Previous Change Order	<u>24,826.90</u>
Cost this Change Order (+ or -)	<u>500.00</u>
New Contract Price including this Change Order	<u>25,326.90</u>

The completion date as set forth in the Contract Documents shall be (unchanged, increased, decreased) by 0 calendar days.

The date for completion of all work will be 45 days from the Notice To Proceed Date.

Description and Justification for Change:

1. Landowner John Becker (P.O. Box 151, Raymond, MT 59256, at phone 895-2584) called the DSL on 8/2/1993 and ask if a coal mine subsidence hole (4 foot diameter and over 2 foot deep) on his property could be fixed. His tractor had dropped into it. The site is just north of the Raymond mine site in the NE bid package. This site had been reclaimed before as the Raymond site (Nick Lockin Mine) in T37N, R54E, SE¼ of Section 34, Sheridan County. Mr. Becker ask that no vegetation be planted after the hole is backfilled.

SURETY CONSENT

The Surety hereby consents to the aforementioned Contract Change Order and agrees that its bond or bonds shall apply and extend to the Contract as thereby modified or amended per this Change Order. The Principal and the Surety further agree that on or after execution of this consent, the penalty of the applicable Performance Bonds or Bonds is hereby increased by \$ 500.00 (100% of the Change Order amount) and the penalty of the applicable Labor and Material Bond or Bonds is hereby increased by \$ 500.00 (100% of the Change Order amount).

COUNTERSIGNED BY MONTANA
RESIDENT AGENT

SURETY

United Fire & Casualty Company


By: 
Seal

Recommended by: Spectrum Engineering
Engineer

William C. Moore 8/11/93
Date

Accepted by: Hallet Reclamation Company
Contractor

Date

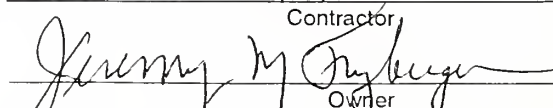Approved by: 
Owner

8/16/93
Date

W. R. Anderson DSL 10/28/93

CHANGE ORDER

ORDER NO. 2

PROJECT TITLE: 1993 Northeastern MT Coal Maintenance Project

MONT A/E or DSL-AMRB: 93-M03

CONTRACT DATE: August 13th, 1993

OWNER: Department of State Lands, Abandoned Mine Reclamation Bureau

CONTRACTOR: Hallett Reclamation Company

Change Orders must be accompanied by an itemized cost breakdown. You are hereby requested to comply with the following changes from the Contract Documents. (Show separate costs for materials, labor, equipment, and miscellaneous. Show percent where applicable.)

ITEM NO.	DESCRIPTION OF CHANGES - ESTIMATED QUANTITIES & UNITS	COST OF CHANGES					TOTAL COST
		MAT'L.S.	LABOR	EQUIP.	MISC.	TOTAL UNIT COST	
1.	Excavated and backfilled 2nd subsidence hole at new Raymond site to a depth of 8 feet below ground surface (26 cubic yards)					7.97	207.22
2.	Backfilled new subsidence at Raymond site (54 cubic yards)					7.97	430.38
3.	Backfilled new subsidence at Nay-Butler (3 CY)					3.90	11.70
4.	Additional backfill volumes over and above bid package estimates						
	Black Diamond (58 cubic yards)					4.44	257.52
	Ahren (25 cubic yards)					4.00	100.00
	Canyon Creek (50 cubic yards)					3.92	196.00
	Seven Sisters (87½ cubic yards)					10.00	875.00
5.	Provide Water (10 Kgal in bid package for dust suppression) - no water actually provided					172.50	(1725.00)
TOTAL COST - MATERIALS, LABOR, EQUIPMENT & MISC.							352.82
OVERHEAD & PROFIT @ _____ %							INC.
GRAND TOTAL - THIS CHANGE ORDER							\$ 352.82

Original Contract Price	<u>\$ 24,826.90</u>
Current Contract Price Adjusted by Previous Change Order	<u>\$ 25,326.90</u>
Cost this Change Order (+ or -)	<u>+ \$ 352.82</u>
New Contract Price including this Change Order	<u>\$ 25,679.72</u>

The completion date as set forth in the Contract Documents shall be (unchanged, increased, decreased) by 0 calendar days.

The date for completion of all work was 9/26/1993.

Description and Justification for Change:

1. One new subsidence hole at new Raymond site (landowner John Becker) in T37N, R54E, SE¼ Section 34. Mr. Becker ask that no vegetation be planted after the hole is backfilled. His tractor fell into the 3'x3'x2½'deep hole. It was excavated to 8 foot depth similar to first one (change order 1). Size of excavation and work task identical to change order 1 (26 CY).
2. New subsidence hole opened up at Raymond site (Myrlen Paulson landowner). It was 10'x12'x12'deep. It required 40 CY of boulders and 14 CY of topsoil (3 feet) to fill it.
3. Backfill new subsidence at Nay-Butler. The hole was 3'x3'x8'deep and required 3 CY of fill.
4. Additional backfill volumes for subsidence and close mine openings as follows:

Site	Bid Estimate	Actual Volume	Extra CY	Bid/ CY	Extra \$\$\$
Black Diamond	36 CY	94 CY	58	\$ 4.44	\$257.52
Ahren	35 CY	60 CY	25	\$ 4.00	\$100.00
Canyon Creek	70 CY	120 CY	50	\$ 3.92	\$196.00
Seven Sisters	65 CY	152½ CY	87½	\$10.00	\$875.00

Entire subsidence backfill bid at \$3,745 for 470 CY or \$7.97/CY. New items 1 and 2 above based on average price per cubic yard bid.

SURETY CONSENT

The Surety hereby consents to the aforementioned Contract Change Order and agrees that its bond or bonds shall apply and extend to the Contract as thereby modified or amended per this Change Order. The Principal and the Surety further agree that on or after execution of this consent, the penalty of the applicable Performance Bonds or Bonds is hereby increased by \$ 352.82 (100% of the Change Order amount) and the penalty of the applicable Labor and Material Bond or Bonds is hereby increased by \$ 352.82 (100% of the Change Order amount).

COUNTERSIGNED BY MONTANA
RESIDENT AGENT

SURETY

By: William C. Moore
Non-Resident Seal License #A11017

Recommended by: Spectrum Engineering _____
Engineer Date 10/9/93

Accepted by: Hallett Reclamation Company _____
Contractor Date 10-15-93

Approved by: W. R. Anderson _____
Owner Date 10/28/93

ATTACHMENT 3

PAYMENT REQUESTS

ATTACHMENT 3

PAYMENT REQUEST

FROM 8/13/1993 TO 9/27/1993

ADDRESS: P.O. BOX 169, LIVINGSTON, MT 59047

Change Order No.	\$
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TOTAL CONTRACT AMOUNT	\$ 25,679.72
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TOTAL DUE CONTRACTOR	10/21/93	\$ 25,422.92
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Date 10/9/93

APPROVAL

Item No.	Description	Contract Quantity	Contract Unit Price	Previous Quantity Requested	Current Quantity Completed	Total Quantity Completed to Date	Total Contract Amount Completed to Date	Amount Due this Payment
1.	Mobilization	1 LS	7096.00	0	1	1	7096.00	7096.00
2.	Provide Water	10 Kgal	172.50	0	0	0	0.00	0.00
3.	Salvage & Replace Coversoil	1 LS	665.00	0	1	1	665.00	665.00
4.	Close Mine Openings	2 Each	462.50	0	2	2	925.00	925.00
5.	Subsidence Backfill	1 LS	3745.00	0	1	1	3745.00	3745.00
6.	Erosion Grading	1 LS	1970.00	0	1	1	1970.00	1970.00
7.	Excavate Air Shaft	1 LS	1190.00	0	1	1	1190.00	1190.00
8.	Neutralize Coal slack	1.13 Acres	2600.00	0	1.13	1.13	2938.00	2938.00
9.	Straw Bales	10 Each	9.00	0	10	10	90.00	90.00
10.	Fertilize, Seed and Mulch	2.93 Acres	1530.00	0	2.93	2.93	4482.90	4482.90
	Change Order Number 1							
1.	Excavate & Backfill Subsidence Hole & Mob.	1 LS	500.00	0	1	1	500.00	500.00
	Change Order Number 2							
1.	Excavate & Backfill Subsidence	26 CY	7.97	0	26	26	207.22	207.22
2.	Backfill Subsidence	54 CY	7.97	0	54	54	430.38	430.38
3.	Backfill Subsidence	3 CY	3.90	0	3	3	11.70	11.70
4.	Additional Backfill Volumes							
	Black Diamond	58 CY	4.44	0	58	58	257.52	257.52
	Ahren	25 CY	4.00	0	25	25	100.00	100.00
	Canyon Creek	50 CY	3.92	0	50	50	196.00	196.00
	Seven Sisters	87.5 CY	10.00	0	87.5	87.5	875.00	875.00
	Materials on Site (Attach Schedule)	--	--	\$	\$	--	\$0.00	\$0.00
TOTALS						100%	\$25,679.72	\$25,679.72

ATTACHMENT 4

ANALYSIS OF CONSULTANT COSTS INCURRED

ANALYSIS OF CONSULTANT COSTS INCURRED
FOR THE MONTANA DEPARTMENT OF STATE LANDS
ABANDONED MINE RECLAMATION BUREAU
AMR PROJECT NUMBER: DSL-AMRB 93-M03
1993 NORTHEASTERN MT COAL MAINTENANCE PROJECT

DATE OF PREPARATION: NOVEMBER 26, 1993

ENGINEERING SERVICE	AMOUNT
DESIGN ENGINEERING:	\$23,443.22
CONSTRUCTION ENGINEERING AND PROJECT ADMINISTRATION COST:	15,450.60
PROJECT ENGINEERING COST:	<u>\$38,893.82</u>
CONSTRUCTION COST:	<u>\$25,679.72</u>
PERCENTAGE ENGINEERING FEES TO CONSTRUCTION COST:	
DESIGN ENGINEERING/CONSTRUCTION COST	91.29%
CONSTRUCTION ENGINEERING/CONSTRUCTION COST	60.17%
TOTAL ENGINEERING COST/CONSTRUCTION COST	151.46%

REMARKS: Services provided included landowner contact and consent, surveying, basic engineering and reclamation design, bid document preparation, pre-bid and pre-construction meetings, construction staking, contract administration, quantity accounting, full time construction/reclamation inspection and final report preparation and project close-out.

ATTACHMENT 5

AS-BUILT DRAWINGS

AND

PHOTO LOCATIONS

STORM WATER CONTROL
BEST MANAGEMENT PRACTICES (BMP'S)

SITE NAME	LEGAL	DISTURBED ACRES	TIME LAPSE ¹	SURFACE WATER LOCATION ²	TEMPORARY SEEDMENT- ATION & EROSION CONTROL	PERMANENT STABILIZATION
BLACK DIAMOND N. MINE	T13N, R60E, SEC. 10 SE ¹ / ₄	0.10	1/2	2	MULCH	PERMANENT SEEDING
NORTH WIBAUX SITE	T15N, R59E, SEC. 13 NE ¹ / ₄	0.20	1/2	0.5	MULCH	PERMANENT SEEDING
MULLENDORE SITE	T16N, R57E, SEC. 30 SW ¹ / ₄	0.10	1	0.2	MULCH	PERMANENT SEEDING
JOHNSON HILL SITE	T20N, R54E, SEC. 31 NE ¹ / ₄	0.80	1	2	MULCH	PERMANENT SEEDING
SCHMIDT SITE	T21N, R54E, SEC. 34 NW ¹ / ₄	0.02	1/2	0.2	MULCH	PERMANENT SEEDING
AHREN SITE	T23N, R53E, SEC. 26 NW ¹ / ₄	0.20	1/2	0.2	MULCH	PERMANENT SEEDING
	T23N, R53E, SEC. 27 NE ¹ / ₄				MULCH	PERMANENT SEEDING
SEVEN SISTERS SITE	T21N, R58E, SEC. 21 SW ¹ / ₄	0.30	1/2	0.2	MULCH	PERMANENT SEEDING
CANYON CREEK SITE	T21N, R59E, SEC. 17 SW ¹ / ₄	0.20	1/2	0.1	MULCH	PERMANENT SEEDING
BEMER SITE	T21N, R56E, SEC. 18 SW ¹ / ₄	0.20	1/2	0.1	MULCH	PERMANENT SEEDING
ANTELOPE II SITE	T34N, R55E, SEC. 16 SE ¹ / ₄	0.20	1/2	0.3	MULCH	PERMANENT SEEDING
MEYER MINE	T35N, R58E, SEC. 05 NE ¹ / ₄	0.10	1/2	0.8	MULCH	PERMANENT SEEDING
RAYMOND MINE	T36N, R55E, SEC. 06 NW ¹ / ₄	0.01	1/2	0.5	MULCH	PERMANENT SEEDING
NIKOLAISEN SITE	T35N, R55E, SEC. 10 SW ¹ / ₄	0.20	1/2	0.1	MULCH	PERMANENT SEEDING
WHITETAIL CREEK SITE	T36N, R50E, SEC. 24 SE ¹ / ₄	0.20	1/2	0	MULCH, STRAW BALES	PERMANENT SEEDING
NAY-BUTLER SITE	T36N, R47E, SEC. 20 SE ¹ / ₄	0.10	1/2	0.1	MULCH	PERMANENT SEEDING
TOTAL ALL SITES		2.93 ³				

The purpose of this project is to reclaim abandoned coal mines. All of the sites addressed herein were previously reclaimed and require some maintenance work. The construction activity will include salvaging and replacing topsoil; providing water for dust control; closing mine adits and shafts; backfilling subsidence, regrading erosional areas, and neutralizing coal slack. Temporary sedimentation and erosion control includes mulching and straw bales. Permanent stabilization includes permanent seeding and fertilizing all disturbed areas.

The Owner is the Department of State Lands, Reclamation Division, Abandoned Mine Reclamation Bureau, 1625 11th Avenue, Helena, Montana 59620 at telephone 1-444-2074. The Project Manager is Joel Chavez.

Good housekeeping for petroleum products, wastes, fertilizer and off-site tracking will be followed by the Contractor as outlined in MPOES Stormwater Discharge Permit and Erosion Control Plan. Good housekeeping chores will include as a minimum:

1. To prevent tracking of sediment off-site, prior to leaving the site, all vehicles shall be washed down on-site as determined by the Engineer at such a location as to contain all washed sediment on-site;
2. Fuel, oil, grease and other such materials shall be stored in one location at each site in such a manner as to prevent spillage and prevent contamination of the surrounding soil. All materials shall be stored in a bermed plastic lined storage area with a capacity of 110 percent of the largest container. Absorbent material shall be available on-site for clean up of any spills; and,
3. Lime and fertilizer shall be stored on pallets off the ground or on plastic ground covers and covered with plastic or in other such manner as to prevent spillage and washing from rain water or wind into surrounding soil or off-site.

FOOTNOTES

1. Estimated time period in days from the start of on-site reclamation construction until the site is permanently fertilized and seeded (long term erosion controls are installed). This is the time from site arrival until demobilization (weather dependent). Temporary stabilization will include mulch and straw bales as outlined above.
2. The distance in miles to the nearest source of potential surface water either flowing or ponded including lakes, rivers, and streams (perennial, intermittent or current dry drainages).
3. 100% of all disturbed areas will be revegetated prior to leaving the site.

LANDOWNER/CONTACT LIST


SITE NAME/LOCATION	LANDOWNER/CONTACT	SITE NAME/LOCATION	LANDOWNER/CONTACT
WIBAUX COUNTY		DANIELS COUNTY	
Black Diamond North Mine NE ¹ / ₄ SE ¹ / ₄ , Sec. 10, T13N, R60E	Earl Smith Rural Route 198 Wibaux, MT 59353 406-795-2554	Whitetail Creek Site W ¹ / ₄ SE ¹ / ₄ , Sec. 24 T36N, R50E	Mr. Larry Meyers Rural Route 1 Flaxville, MT 59222 406-779-3637
North Wibaux Site SE ¹ / ₄ NE ¹ / ₄ , Sec. 13, T15N, R59E	Mrs. Lanny Peters 708 1st Avenue South Wibaux, MT 59353 406-795-8119	Nay-Butler Site SE ¹ / ₄ SE ¹ / ₄ , Sec. 20, T36N, R47E	Tade, Inc. Marvin Tade-President Rural Route Scobey, MT 59263 406-783-5514
DAWSON COUNTY		RICHLAND COUNTY	
Mul Wendore Site NE ¹ / ₄ SW ¹ / ₄ , Sec. 30, T16N, R57E	Donald O. Mul Wendore 323 Clough St. Glenwood, MT 59330 406-369-5314	Seven Sisters NW ¹ / ₄ SW ¹ / ₄ , Sec. 21 T21N, R58E	Ed Clemmer Rural Route Crane, MT 59217 406-798-3407
Johnson Hill Site SE ¹ / ₄ NE ¹ / ₄ , Sec. 31 T20N, R54E	Lloyd & Kathryn Hosteller 522 Road 524 Bloomfield, MT 59315 406-583-7758	Ahren Mine NW ¹ / ₄ NW ¹ / ₄ , Sec. 26 T23N, R53E	Rhines Farming Corp. Harold Rhines P.O. Box 19 Sidney, MT 59270 406-774-3465 or 482-3750
Schmidt Site SW ¹ / ₄ NW ¹ / ₄ , Sec. 34, T21N, R54E	Warren Schwartz Box 1002 Wolf Point, MT 59201 406-653-1168	NE ¹ / ₄ NE ¹ / ₄ , Sec. 27 T23N, R53E	Tim Bouchard Route 2, Box 2366 Sidney, MT 59270 406-482-4125
SHERIDAN COUNTY		Canyon Creek Site NW ¹ / ₄ SW ¹ / ₄ , Sec. 17 T21N, R59E	Tod V. & Susan L. Gorder Box 4054 Skaa Route Sidney, MT 59270 406-482-2254
Antelope I Site SE ¹ / ₄ SE ¹ / ₄ , Sec. 16 T34N, R55E	MT Department of State Lands Attn: Jeff Hagener 1625 11th Avenue Helena, MT 59620 406-444-2074	Flom Mine (DROPPED) NW ¹ / ₄ NW ¹ / ₄ , Sec. 6 T23N, R59E LANDOWNER CONSENT WITHDRAWN	Willie & Donna Panasuk Guard Route, Box 134A Sidney, MT 59270 406-798-3683
Meyer Mine NW ¹ / ₄ NE ¹ / ₄ , Sec. 5 T35N, R58E	Donald Shoat (Contact) 518 Glenwood Plentywood, MT 59254 406-765-1475	Bemer Site NE ¹ / ₄ SW ¹ / ₄ , Sec. 18 T27N, R56E	Howard & Julie Bemer Box 1599 Poplar, MT 59255 406-768-3601
Raymond Mine SW ¹ / ₄ NW ¹ / ₄ , Sec. 6 T36N, R55E	Myrlan Paulson Box 122 Raymond, MT 59256 406-895-2113		
Nikolaissen Site SE ¹ / ₄ SW ¹ / ₄ , Sec. 10 T35N, R55E	Lucille C. King-Stewart 15 Ash Drive Wayburn, Sask. S4H0R9 Canada 306-842-8141		

1993 NORTHEASTERN MT. COAL MAINTENANCE PROJECT

LOCATED IN
DANIELS, DAWSON, RICHLAND,
SHERIDAN & WIBAUX COUNTIES, MONTANA

DSL/AMRB 93-MO3

PREPARED FOR:
MONTANA DEPARTMENT OF STATE LANDS
ABANDONED MINE RECLAMATION BUREAU

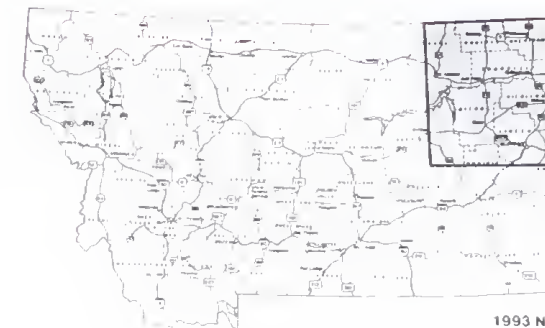

1993 NORTHEASTERN MT.
COAL MAINTENANCE
PROJECT AREA

STATE LOCATION MAP

MAP SHEET INDEX

DESCRIPTION	SHEET NO.
COVER SHEET	1
BLACK DIAMOND NORTH MINE	2
NORTH WIBAUX MINE	3
MULLENDORE	4
JOHNSON HILL	5
SCHMIDT	6
AHREN MINE	7
SEVEN SISTERS MINE	8
CANYON CREEK MINE	9
FLOM MINE AREA 1 - DROPPED (LANDOWNER CONSENT DENIED)	10
BEMER MINE	11
ANTELOPE II MINE	12
MEYER MINE	13
RAYMOND MINE	14
NIKOLAISEN MINE	15
WHITETAIL CREEK	16
NAY BUTLER MINE	17
PHOTO DESCRIPTION SHEET	18

ARCHAEOLOGICAL NOTICE

THERE ARE KNOWN ARCHAEOLOGICAL SITES IN THE VICINITY OF SOME OF THE MAINTENANCE SITES WITHIN THIS BIO PACKAGE

ANY ARCHAEOLOGICAL MATERIALS NEAR THE CONSTRUCTION AREAS WILL BE MARKED BY THE OWNER. AT NO TIME SHALL THESE ARCHAEOLOGICAL MATERIALS BE DISTURBED WITHOUT WRITTEN PERMISSION FROM THE OWNER

HAZARD NOTICE

MANY POTENTIAL HAZARDS EXIST AT THESE MINE SITES. THE EXTENT OF THESE HAZARDS IS NOT FULLY KNOWN

THE CONTRACTOR, SUBCONTRACTORS, AND THEIR EMPLOYEES WILL COMPLY WITH ALL APPLICABLE LOCAL, STATE, AND FEDERAL SAFETY REGULATIONS IN THE PERFORMANCE OF THE REQUIRED WORK. CONTRACTORS AND OTHER PERSONS WORKING AT THE SITES SHALL BE FULLY RESPONSIBLE FOR APPRISING THEMSELVES OF ANY HAZARDOUS CONDITIONS WHICH MAY EXIST AND SHALL TAKE WHATEVER STEPS ARE NECESSARY TO INSURE THEIR SAFETY AND THE SAFETY OF OTHERS WHILE PERFORMING THEIR DUTIES.

ENGINEER'S CERTIFICATE

THE MAPS AND PLANS WHICH FOLLOW WERE ORIGINALLY PREPARED UNDER THE DIRECTION OF VARIOUS ENGINEERS AND FIRMS IN ORDER TO COMPLETE SITE RECLAMATION WORK OVER THE LAST 10 YEARS. THESE PLANS WERE NOT ALTERED. THE 1993 NORTHEASTERN MT. COAL MAINTENANCE PROJECT USES THE ORIGINAL PLANS WITH THE MAINTENANCE WORK IDENTIFIED IN A DIFFERENT TYPOGRAPHIC STYLE. ONLY THE WORK IDENTIFIED AS MAINTENANCE ON THESE SITE PLANS AND IN THE BIO PACKAGE IS TO BE COMPLETED.

I HEREBY CERTIFY THAT THE MAINTENANCE WORK SHOWN ON THESE MAPS AND PLANS WAS PREPARED BY ME OR UNDER MY DIRECT SUPERVISION. I CANNOT ACCOUNT FOR THE ACCURACY OF THE ORIGINAL SITE PLANS AND THE WORK PERFORMED. LIKEWISE THE ENGINEER WHO STAMPED THE ORIGINAL PLANS ASSUMES NO RESPONSIBILITY FOR THE MAINTENANCE WORK ADDITIONS

William C. Maehl
William C. Maehl
Montana P.E. No. 5274 PE


ADDITIONAL INFORMATION PERTAINING TO THESE SITES MAY EXIST IN THE DEPARTMENT OF STATE LANDS' FILES OR AT SPECTRUM ENGINEERING'S OFFICE. THIS MATERIAL IS AVAILABLE FOR REVIEW BY ANY INTERESTED PARTY

REDUCED PRINTS ARE APPROX. 1/2 ORIGINAL SCALE

PREPARED BY:


SPECTRUM ENGINEERING
Mining and Civil Engineers

4th Avenue Plaza
1413 4th Avenue North
Billings, Montana 59101

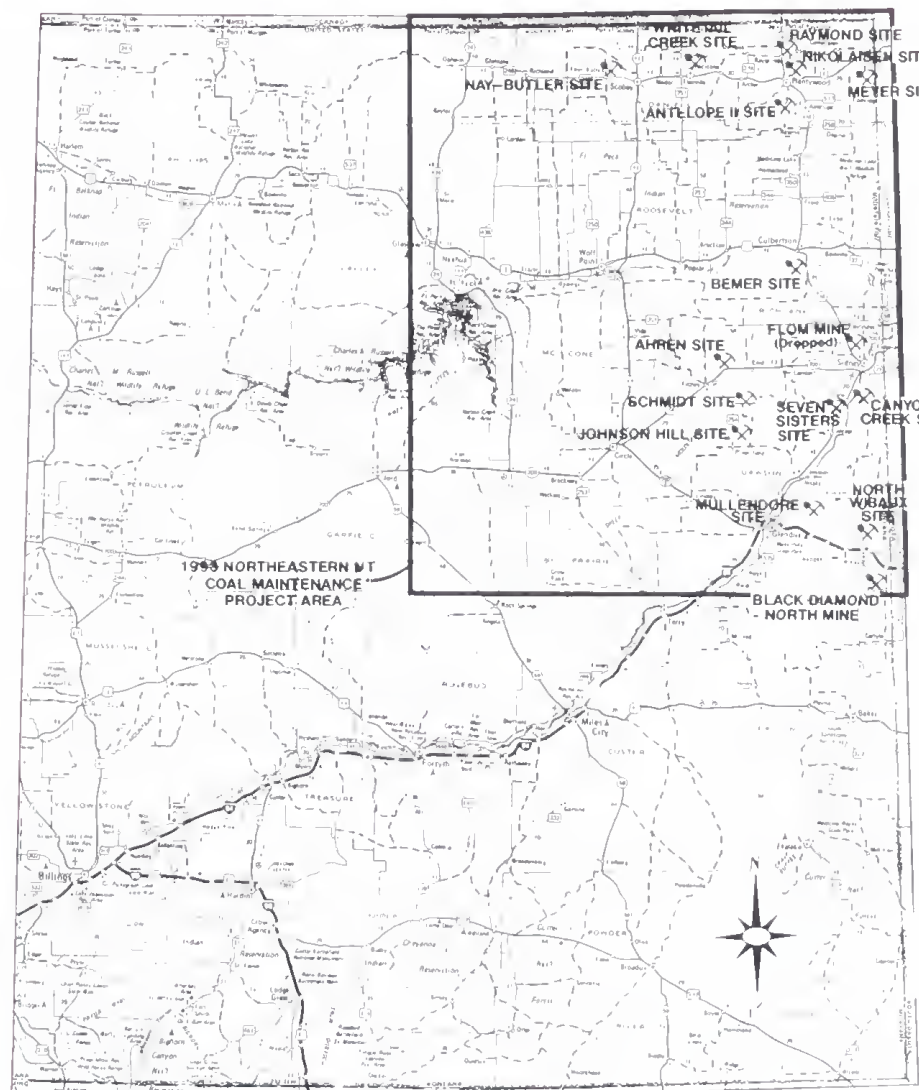

AREA MAP

SCALE IN MILES

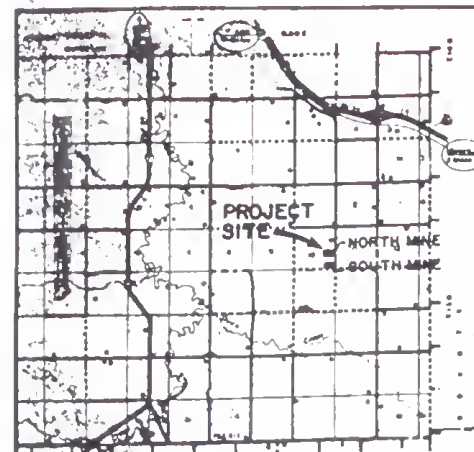


LOCATION MAP
SCALE: 1/2"=1 MI.

NOTICE
An abandoned coal mine underlies this site.
Many potential hazards exist. The extent of these hazards is not fully known. Contractors and other persons working at the site shall apprise themselves of the conditions and take whatever steps are deemed necessary to insure safety while performing their duties.

NOTICE
HYDROGEN SULFIDE GAS HAS BEEN DETECTED AT THE MINE SITE. HYDROGEN SULFIDE IS A VERY LETHAL GAS AND SHOULD BE TREATED WITH EXTREME CAUTION. THE CONTRACTOR SHALL PROVIDE APPROPRIATE CONTINUOUS MONITORING EQUIPMENT FOR ALL PERSONNEL AND VISITORS TO THE MINE SITE.


THE CONTRACTOR SHOULD NOTE THAT THE HIGHEST RISK OF EXPOSURE TO HYDROGEN SULFIDE GAS OCCURS AT BOREHOLES, MINE VOID ACCESS POINTS, WELLS AND MINE WATER DISCHARGE POINTS. THE CONTRACTOR'S MONITORING SHOULD NOT, HOWEVER, BE LIMITED TO THESE POINTS.

B.H. 101966.01
SC0118 14-40-2

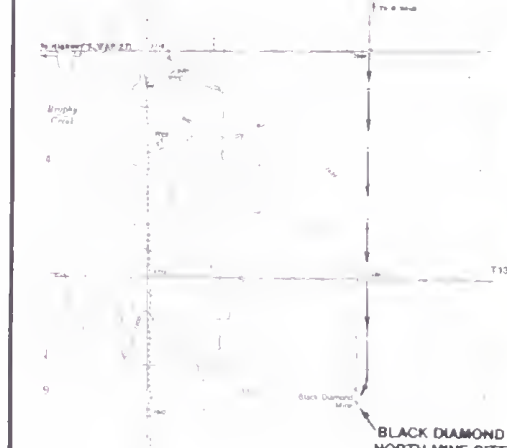

BLACK DIAMOND NORTH MINE SITE

SITE LOCATION MAP
SCALE: 1/2"=1 MI.

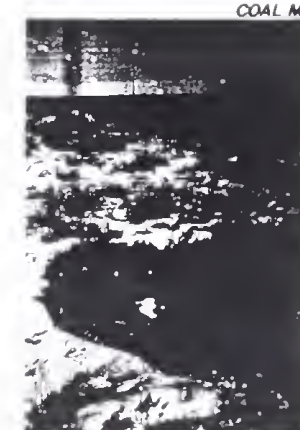

Picture 1 shows subsidence hole A looking Northeast.



Picture 2 shows subsidence hole B looking Northeast.


LEGEND

PAVED ROAD	TREES	EXISTING BORE HOLE
IMPROVED ROAD	BRUSH	B.H. ELEVATION
WATER LINE	POLE	B.H. BORE HOLE (BY L.C. HANSON CO.)
BRIDGE	NEW BORE HOLE	T.C. TOP OF COAL
EXCAVATION FOR VOID ACCESS	MINES OUTLINE	B.C. BOTTOM OF COAL
CULVERT	HYDROGRAPHIC CONTOUR	Distance Below Surface Level
FENCE	DEPRESSION CONTOUR	T.V. TOP OF VOID
RAILROAD	ENCLOSURE	B.V. BOTTOM OF VOID
POWER POLE	AREA OF SUBSIDENCE BY DEPTH	SPOT ELEVATION
AERIAL TARGET	FIELD LINE	SPRINKLER
CONVEYOR POINT	CAUTION SIGN	WATER TO LATERAL VALVE
		SURVEY POINT NO.

NO	NORTH	EAST	ELEV
30	5,000.00	10,000.00	1000.00
H2451	5,037.32	10,072.63	1000.54
H2462	4,849.63	10,095.63	993.88
V2461	4,818.36	9,566.18	984.17
V2451A	5,091.67	9,786.07	991.28
V244	5,352.53	9,851.64	993.43
H2442	5,346.54	10,149.77	998.22
37	5,029.77	10,206.50	1001.43
43	4,689.12	10,171.21	989.50
46	5,070.36	10,173.16	1000.00
47	5,406.41	10,173.53	998.20

Horizontal Grid North Based On Bearing 62°48'09". C.P. To Point H2451. Vertical Datum Based On Assumed Elevation 1000.00' At C.P. Ground Control Surveys Conducted December 1, 1981 By Associated Surveys, Inc., Billings, Montana

Topography Prepared From Hasselblad Camera 50 mm Distagon Lens. Aerial Photography 1:10500, August 27, 1980 with Lens Correction Applied. This Topography is of Reconnaissance Class And Has Not Been Field Checked. Associated Surveys, Inc., Billings, Montana

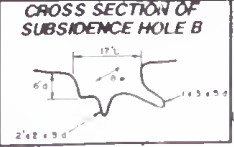

DONALD B. CHAFFEE
LAND OWNER-NE 1/4
SECTION 10

COAL MAINTENANCE
1. Backfill two subsidence holes (17' x 8' w x 6' deep, 7' x 7' 1/2' w x 2' deep) with 36 cubic yards of borrow material.
2. Fertilize, seed & mulch backfilled subsidence holes, borrow source & all other disturbed areas - 0.1 acres.

ENLARGED HOLE 12'x20' DEEP

UTILITY-LAND OWNERS

LANDOWNER EARL SMITH
RURAL ROUTE BOX 198
WIBAUX, MT. 59353
PHONE (406) 795-2554

OWNER REPRESENTATIVE DEPT. OF STATE LANDS
ATTN: JOEL CHAVEZ
1625 11TH AVE
HELENA, MT.
PHONE (406) 444-2074

TRANSMISSION POWER LINE UNITED STATES DEPT. OF INTERIOR
(JAWSON COUNTY SUBSTATION)
ATTN: MICHAEL FISHER (MOR-FRI)
PHONE (406) 365-4440
JAMESTOWN DISPATCH (SAT & SUN)
PHONE 1-800-437-9708

POWER GOLDEN WEST ELECTRIC CO-OP
WIBAUX, MT.
PHONE (406) 795-2423

TELEPHONE MOUNTAIN BELL
BILLINGS, MT.
PHONE (406) 657-3111

BORROW AREA

24+50 TO 25+00 CONSTRUCT TRANSITION FROM TYPICAL SECTION TO MATCH EXIST. ROAD. SEE SHT. 4.

PROVIDE ELEC. SERVICE TO NEW METER POLE 2' SO OF FENCE COR.

24+90 INSTALL 40' F. 12" R.C.P. - SEE SHT. 4

CONSTRUCT DRAIN DITCH SEE SHT. 4

18+00 TO 25+00 RECONSTRUCT COUNTY ROAD W/ GRAVEL SURFACE SEE SHT. 4 & 5.

NORTH CONSTRUCTION LIMITS

BORROW AREA NO. 2 LIMITS

BORROW AREA NO. 2

WEST CONSTRUCTION LIMITS

BORROW AREA NO. 1

INSTALL FENCE POST & OWNER PROVIDED SIGN (TYP)

BORROW AREA NO. 1 LIMITS

WATER DISPOSAL SYSTEM SEE SHT. 3

SPRINKLER LATERALS

SUMMER FALLOW

TOP SOIL STOCK PILE AREA

SOUTH CONSTRUCTION LIMITS

TOWER

POWER TRANSMISSION LINE

VICINITY MAP

COAL MAINTENANCE BLACK DIAMOND NORTH MINE SITE
SECTION 10 T13N R60E
WIBAUX COUNTY MONTANA

Date: February 1993
Project No.: 2-18
Spectrum Engineering
Mining and Civil Engineers
Billings, Montana

18+00 TO 18+50 - CONSTRUCT TRANSITION FROM EXIST. ROAD TO TYPICAL SECTION SEE SHT. 4

NOTES

1. A MAP OF THE BLACK DIAMOND MINE IS NOT AVAILABLE. THE EXTENT OF THE MINE VOIDING, THEREFORE, IS UNKNOWN AND WAS NOT SHOWN.

2. THE LOCATIONS FOR UTILITIES ARE APPROXIMATE AND THE CONTRACTOR MUST VERIFY.



CONSTRUCTION PHOTOS

AS-BUILT DRAWING AND PHOTO INDEX

L. C. Hanson Co.
CONSULTING CIVIL, SANITARY, MUNICIPAL AND STRUCTURAL ENGINEERS
HELENA, MONTANA

BLACK DIAMOND - RECLAMATION PLAN
NORTH MINE PLAN AND GENERAL LAYOUT


DRAWN BY: LCH CO
CHECKED BY: JH
APPROVED BY:
DATE: 5-31-84
SHEET NO.: 1
OF 5
82-15-04

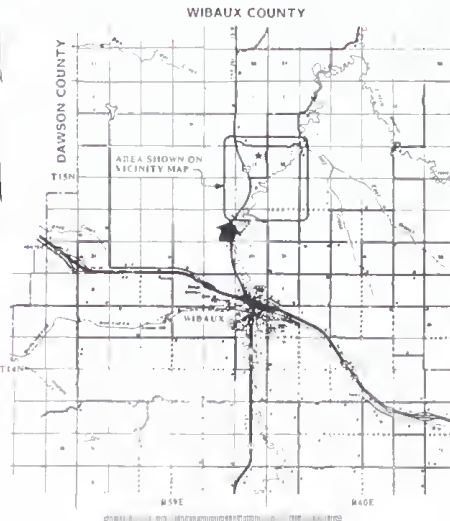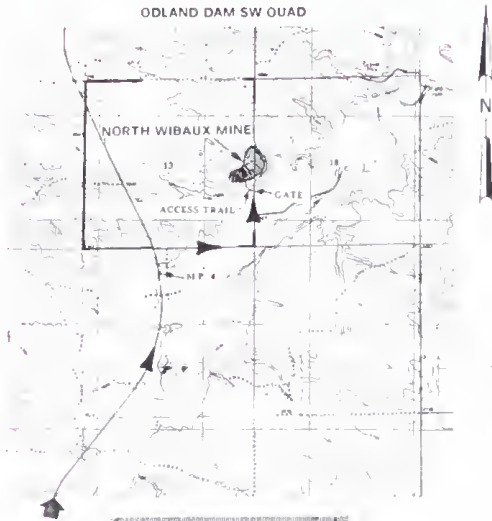

Picture 1 is looking south-southeast at subsidence hole B (hole A is on edge) and coal stock pile is in the distance

NOTICE
ABANDONED COAL MINE(S) UNDERLIE THIS SITE. MANY POTENTIAL HAZARDS EXIST. THE EXTENT OF THESE HAZARDS IS NOT FULLY KNOWN. CONTRACTORS AND OTHER PERSONS WORKING AT THE SITE SHALL APPRAISE THEMSELVES OF THE CONDITIONS AND TAKE WHATEVER STEPS ARE DEEMED NECESSARY TO INSURE SAFETY WHILE PERFORMING THEIR DUTIES.

ADDITIONAL INFORMATION PERTAINING TO THIS SITE MAY EXIST IN THE DEPARTMENT OF STATE LANDS' FILES OR AT THE OFFICES OF THEIR ENGINEERING REPRESENTATIVE AND SUCH MATERIAL IS AVAILABLE FOR REVIEW BY THOSE INTERESTED IN DOING SO.

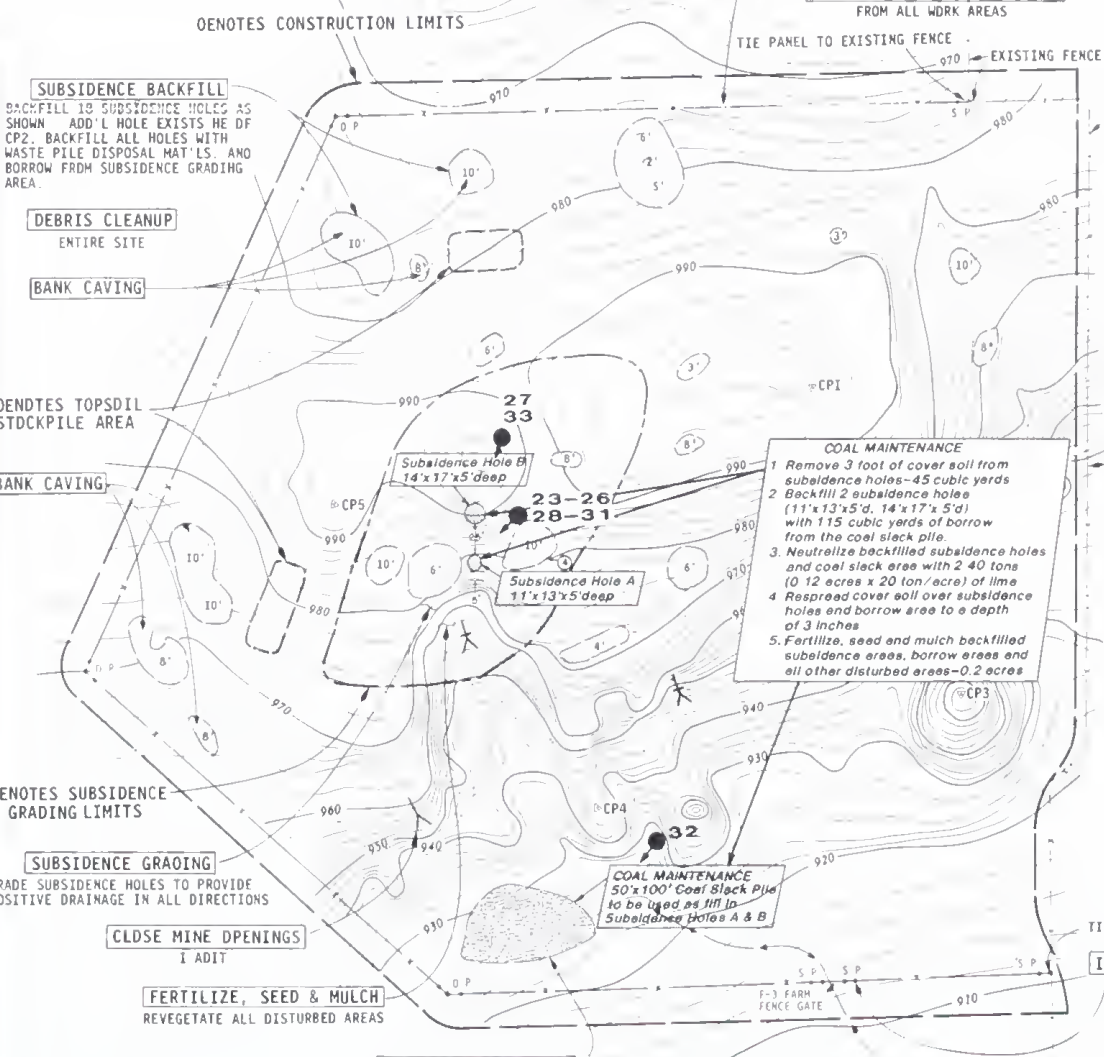

- LEGEND
- PAVED ROAD
 - IMPROVED ROAD
 - ACCESS ROUTE
 - FENCE
 - BURIED POWER LINE
 - BURIED TELEPHONE LINE
 - B N 3 BOREHOLE (1 & NO.)
 - TREES
 - DRAINAGE
 - POND
 - S P SINGLE PANEL
 - SWAMP
 - INDEX CONTOUR
 - INTERMEDIATE CONTOUR
 - DEPRESSION CONTOUR
 - BUILDING
 - SUBSIDIENCE (1 & DEPTH)
 - FISSURES
 - OPEN ADIT
 - CLOSED ADIT
 - WASTE PILE
 - DOUBLE PANEL

CONSTRUCTION PHOTOS

ITEM DESCRIPTION	UNITS
SALVAGE & REPLACE TOPSOIL	680 C.Y.
CLOSE MINE OPENINGS	1 EACH
BANK CAVING	4 HRS.
SUBSIDIENCE BACKFILL	3900 C.Y.
SUBSIDIENCE GRAING	1000 C.Y.
WASTE PILE DISPOSAL	450 C.Y.
PROVIDE WATER	
COMPACT	950 MGAL
DUST CONTROL	50 MGAL
FERTILIZE, SEED, MULCH	1.75 ACRES
FARM FENCE, TYPE F-3M	1800 L.F.
DOUBLE PANEL	3 EACH
SINGLE PANEL	4 EACH
F-3 FARM FENCE GATE	16 L.F.

COAL MAINTENANCE
1 Remove 3 foot of cover soil from subsidence holes - 45 cubic yards
2 Backfill 2 subsidence holes (11'x13'x5'd, 14'x17'x5'd) with 115 cubic yards of borrow from the coal stock pile.
3. Neutralize backfilled subsidence holes and coal stock area with 240 tons (0.12 acres x 20 ton/acre) of lime
4 Respread cover soil over subsidence holes and borrow area to a depth of 3 inches
5. Fertilize, seed and mulch backfilled subsidence areas, borrow areas and all other disturbed areas - 0.2 acres

LANDOWNER
HRS. LANNY PETERS
708 1st AVE. SOUTH
WIBAUX, MT. 59153
PHONE (406) 795-8119

STATE OF MONTANA
DEPT. OF STATE LANDS
RECLAMATION DIVISION


COAL MAINTENANCE
NORTH WIBAUX MINE SITE
SECTION 13 T15N R59E
WIBAUX COUNTY MONTANA
Date: February 1993
SPECTRUM ENGINEERING
Mining and Civil Engineers
Billings, Montana

POINT	NORTH	EAST	ELEVATION
CP1	2000 000	2000 000	1000 000
CP2	2337 221	2087 156	981 251
CP3	1847 785	2216 068	953 313
CP4	1631 647	2014 272	945 510
CP5	1743 098	1723 753	994 074

08-10-09	4	1" = 50'	5/16/99	1-16-99	LBP
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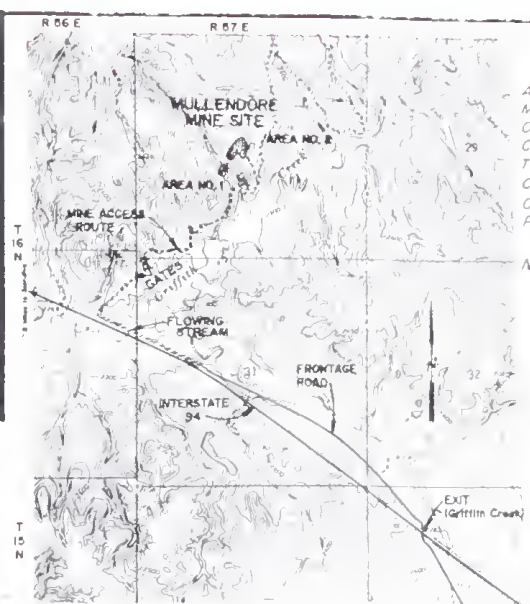
NORTH WIBAUX MINE
GENERAL LAYOUT & SITE PLAN

L. C. Hanson Co.
CONSULTING ENGINEERS
SANITARY, MUNICIPAL AND STRUCTURAL ENGINEERS
HELENA, MONTANA

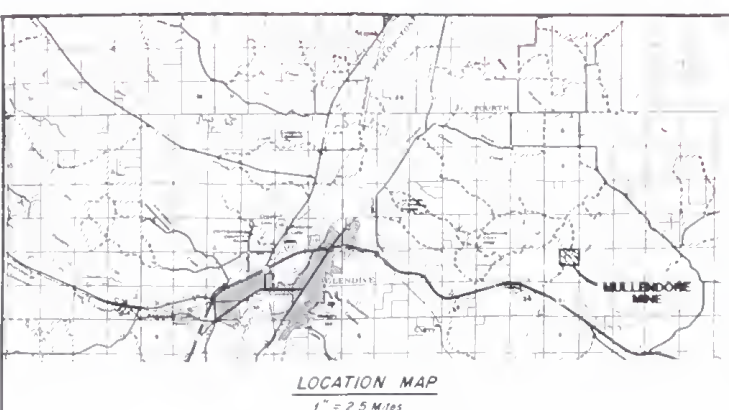

ESTIMATED QUANTITIES AREA NO. 1	
ITEM DESCRIPTION	UNITS
SALVAGE & REPLACE TOPSOIL	932 CY
BANK CAVING	3 HOURS
CLOSE MINE OPENING	230 CY
SUBSIDENCE GRADING	698 CY
PROVIDE WATER	12.6 MGAL
Compaction	1.4 MGAL
FERTILIZE, SEED & MULCH	1.8 ACRES
CONSTRUCT FENCE (1/2 3M)	95 L.F.
Gate	16 L.F.
Single Panels	2 EACH
Double Panels	5 EACH


ESTIMATED QUANTITIES AREA NO. 2	
ITEM DESCRIPTION	UNITS
SALVAGE & REPLACE TOPSOIL	10489 CY
BANK CAVING	3 HOURS
SUBSIDENCE BACKFILL	730 CY
SUBSIDENCE GRADING	10489 Y
PROVIDE WATER	152.6 MGAL
Compaction	16.6 MGAL
FERTILIZE, SEED & MULCH	3.7 ACRES
CONSTRUCT FENCE (1/2 3M)	155 L.F.
Gate	22 L.F.
Single Panels	2 EACH
Double Panels	5 EACH



NOTICE
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NOTE ACCESS ROUTE AND WORK AREAS WILL BE FIELD STAKED BY THE OWNERS REPRESENTATIVE.

LANDOWNER CONTACT PERSON
Donald D. Mullendore
323 Clough Street
Glendive, Montana 59330
Phone (406) 365-5314

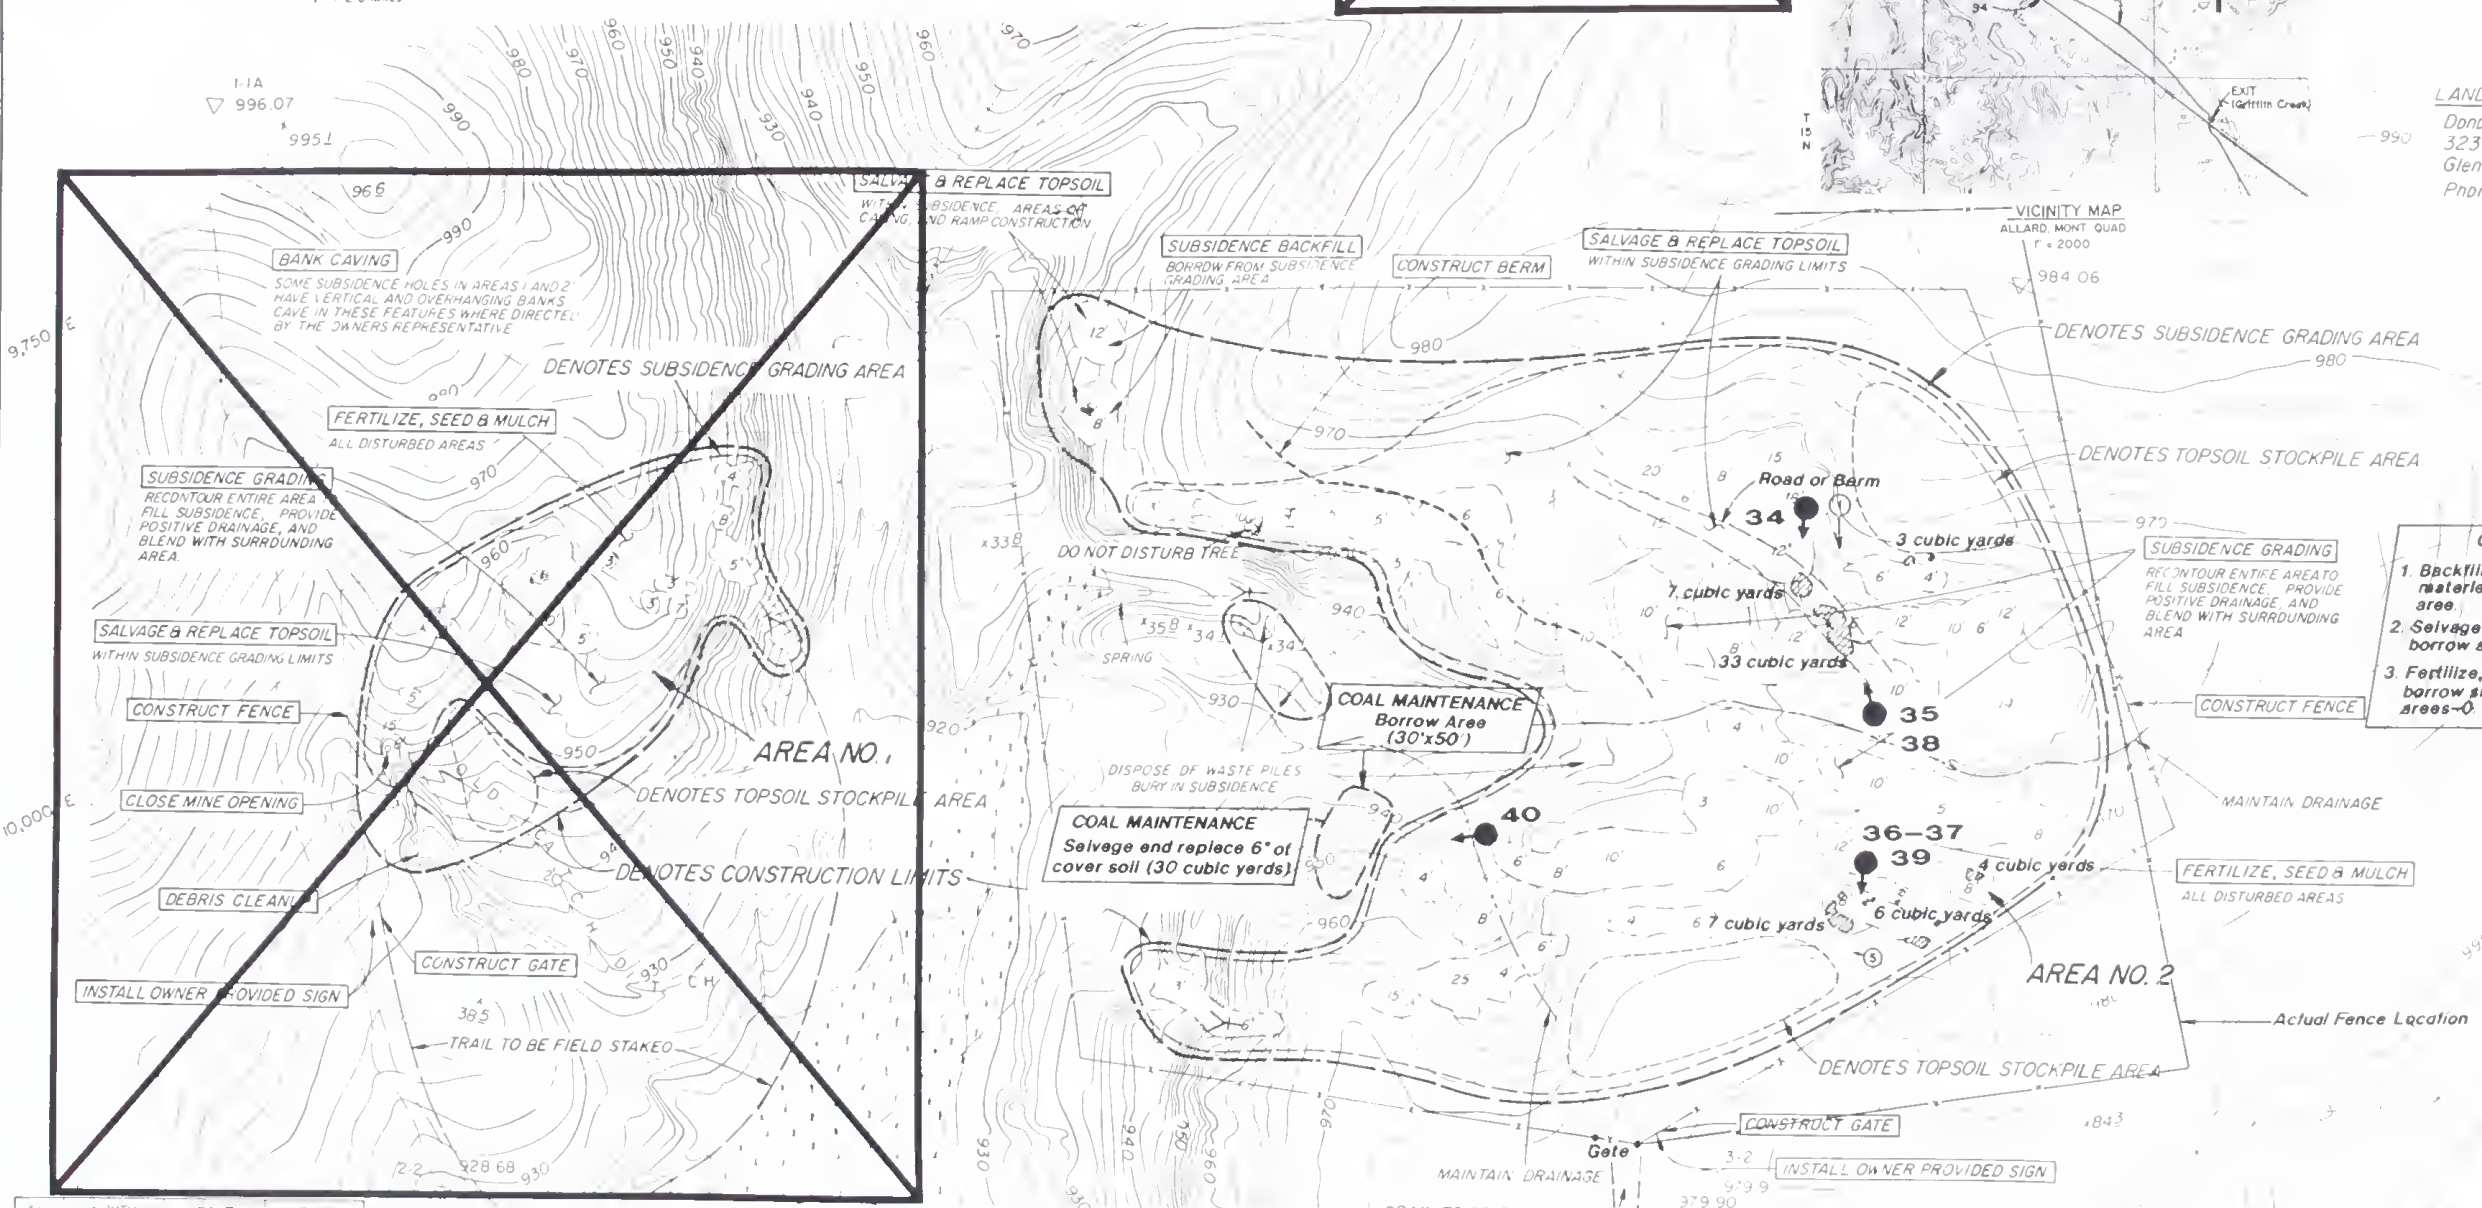


N	E	ELEV
1	4.361	961.4
2	4.361	961.4
3	4.361	961.4
4	4.361	961.4
5	4.361	961.4
6	4.361	961.4
7	4.361	961.4
8	4.361	961.4
9	4.361	961.4
10	4.361	961.4
11	4.361	961.4
12	4.361	961.4
13	4.361	961.4
14	4.361	961.4
15	4.361	961.4
16	4.361	961.4
17	4.361	961.4
18	4.361	961.4
19	4.361	961.4
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21	4.361	961.4
22	4.361	961.4
23	4.361	961.4
24	4.361	961.4
25	4.361	961.4
26	4.361	961.4
27	4.361	961.4
28	4.361	961.4
29	4.361	961.4
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31	4.361	961.4
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44	4.361	961.4
45	4.361	961.4
46	4.361	961.4
47	4.361	961.4
48	4.361	961.4
49	4.361	961.4
50	4.361	961.4

Geodetic Grid North Based On Magnetic Bearing
Vertical Datum Based On Assumed Elevation
1000.00' At C.P. Ground Control Surveys
Conducted November 21, 1984 By Montana Department of State Lands.


Topography Prepared From Hasselblad Camera,
50 MM Distagon Lens, Aerial Photography,
1:10,000, October 24, 1984, With Lens
Correction Applied. This Topography Has Not
Been Field Checked.
Associated Surveys, Inc., Billings, Montana

CONSTRUCTION PHOTOS

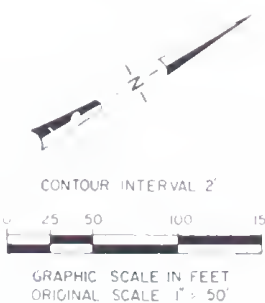


COAL MAINTENANCE
MULLENDORE SITE
SECTION 30, T16N R57E
DAWSON COUNTY, MONTANA

Date: February 1993
Sheet No: 4 of 18
SPECTRUM ENGINEERING
Mining and Civil Engineers
Billings, Montana

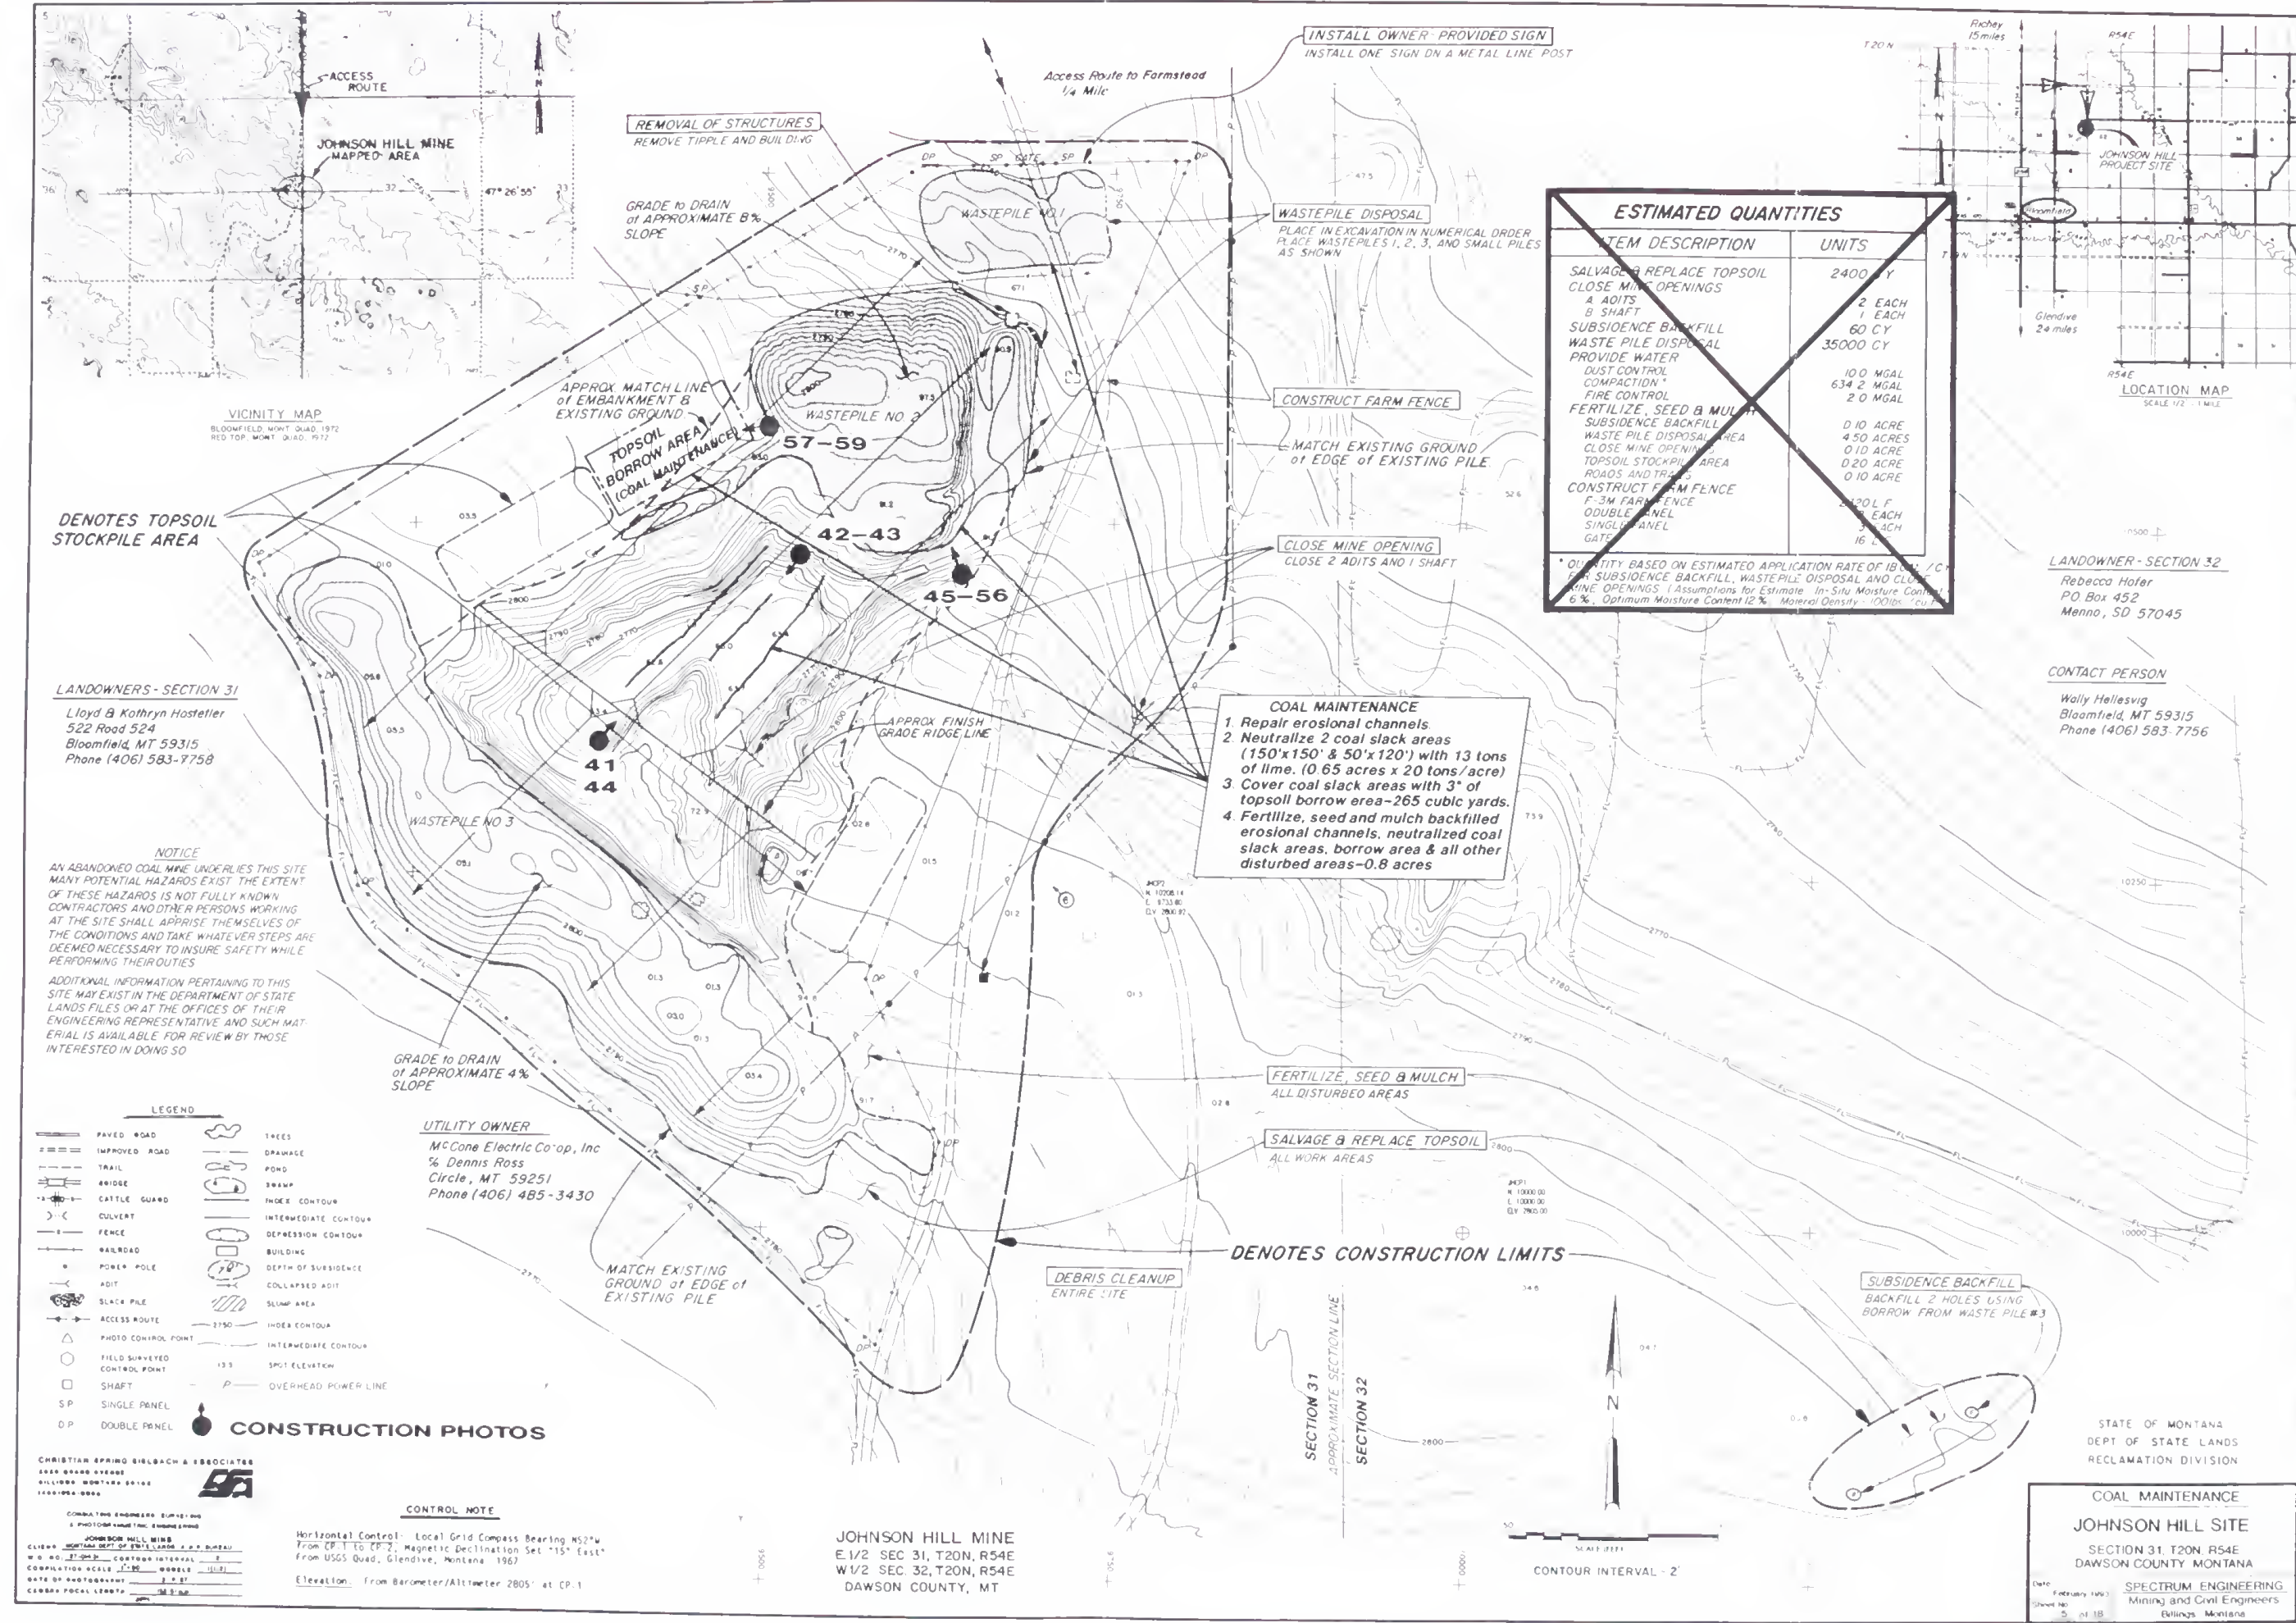



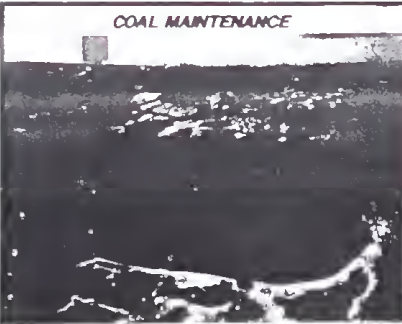

1. Looking east at subsidence hole and AML Reclamation sign.

- COAL MAINTENANCE**
1. Backfill air shaft which has subsided with 13 cubic yards of borrow (hole is 7'w x 11'l x 4'd with smaller 1'd, 2' deep hole in bottom.)
 2. Fertilize, seed and mulch all disturbed areas—0.02 acres.

VICINITY MAP
CLAY BUTTE QUAD
SCALE 1"=2000'

Coal Maintenance Borrow Area
25'x25'x1 1/2' deep

LOCATION MAP
SCALE 1/2"=1 MI

SALVAGE & REPLACE TOPSOIL
ALL WORK AREAS

INSTALL OWNER PROVIDED SIGN
METAL SIGN ON NEW WOODEN POST

DENOTES BORROW AREA

DEBRIS CLEANUP
ENTIRE SITE

CLOSE MINE OPENING
TWO AIR SHAFTS AND ONE ADIT

FERTILIZE, SEED & MULCH
ALL DISTURBED AREAS

DENOTES CONSTRUCTION LIMITS

SCALE (FEET)
CONTOUR INTERVAL - 20'

LANDOWNER/CONTACT PERSON
Warren Schwartz
P.O. Box 1002
Wolf Point, MT 59201
Ph (406) 653-1168

SCHMIDT SITE
NW 1/4, SECTION 34, T21N, R53E
DAWSON COUNTY, MONT

ITEM DESCRIPTION	UNITS
SALVAGE & REPLACE TOPSOIL	40 C.Y.
CLOSE MINE OPENINGS	1 EACH
A. ADIT	1 EACH
B. SHAFT	2 EACH
PROVIDE WATER	2.3 MGAL
COMPACTION	2.0 MGAL
DUST CONTROL	0.02 ACRE
FERTILIZE, SEED & MULCH	0.02 ACRE
CLOSE MINE OPENINGS	0.02 ACRE
BORROW AREA	0.02 ACRE
TOPSOIL STOCKPILE AREA	0.02 ACRE
ROADS AND TRAILS	0.02 ACRE

QUANTITY BASED ON ESTIMATED APPLICATION RATE OF 18 GAL/C.Y. FOR SUBSIDENCE GRADING AND SUBSIDENCE BACKFILL, WASTE PILE DISPOSAL, AND/OR CLOSE MINE OPENING MATERIAL. (Assumptions for Estimate: In-Situ Moisture Content - 61; Optimum Moisture Content - 61; Material Density - 100 lbs./cu. ft.)





NOTICE

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- LEGEND**
- PAVED ROAD
 - IMPROVED ROAD
 - TRAIL
 - BRIDGE
 - CATTLE GUARD
 - CULVERT
 - FENCE
 - RAILROAD
 - POWER POLE
 - ADIT
 - SLACK PILE
 - ACCESS ROUTE
 - TREES
 - ORSHAGE
 - POND
 - SHRUB
 - INDEX CONTOUR
 - INTERMEDIATE CONTOUR
 - DEPRESSION CONTOUR
 - BUILDING
 - DEPTH OF SUBSIDENCE
 - COLLAPSED ADIT
 - SLUMP AREA
 - SHAFT

CONSTRUCTION PHOTOS





COAL MAINTENANCE	
SCHMIDT SITE	
SECTION 34, T21N, R53E DAWSON COUNTY, MONTANA	
Date: February 1993	SPECTRUM ENGINEERING Mining and Civil Engineers Billings, Montana
Sheet No. 6 of 18	

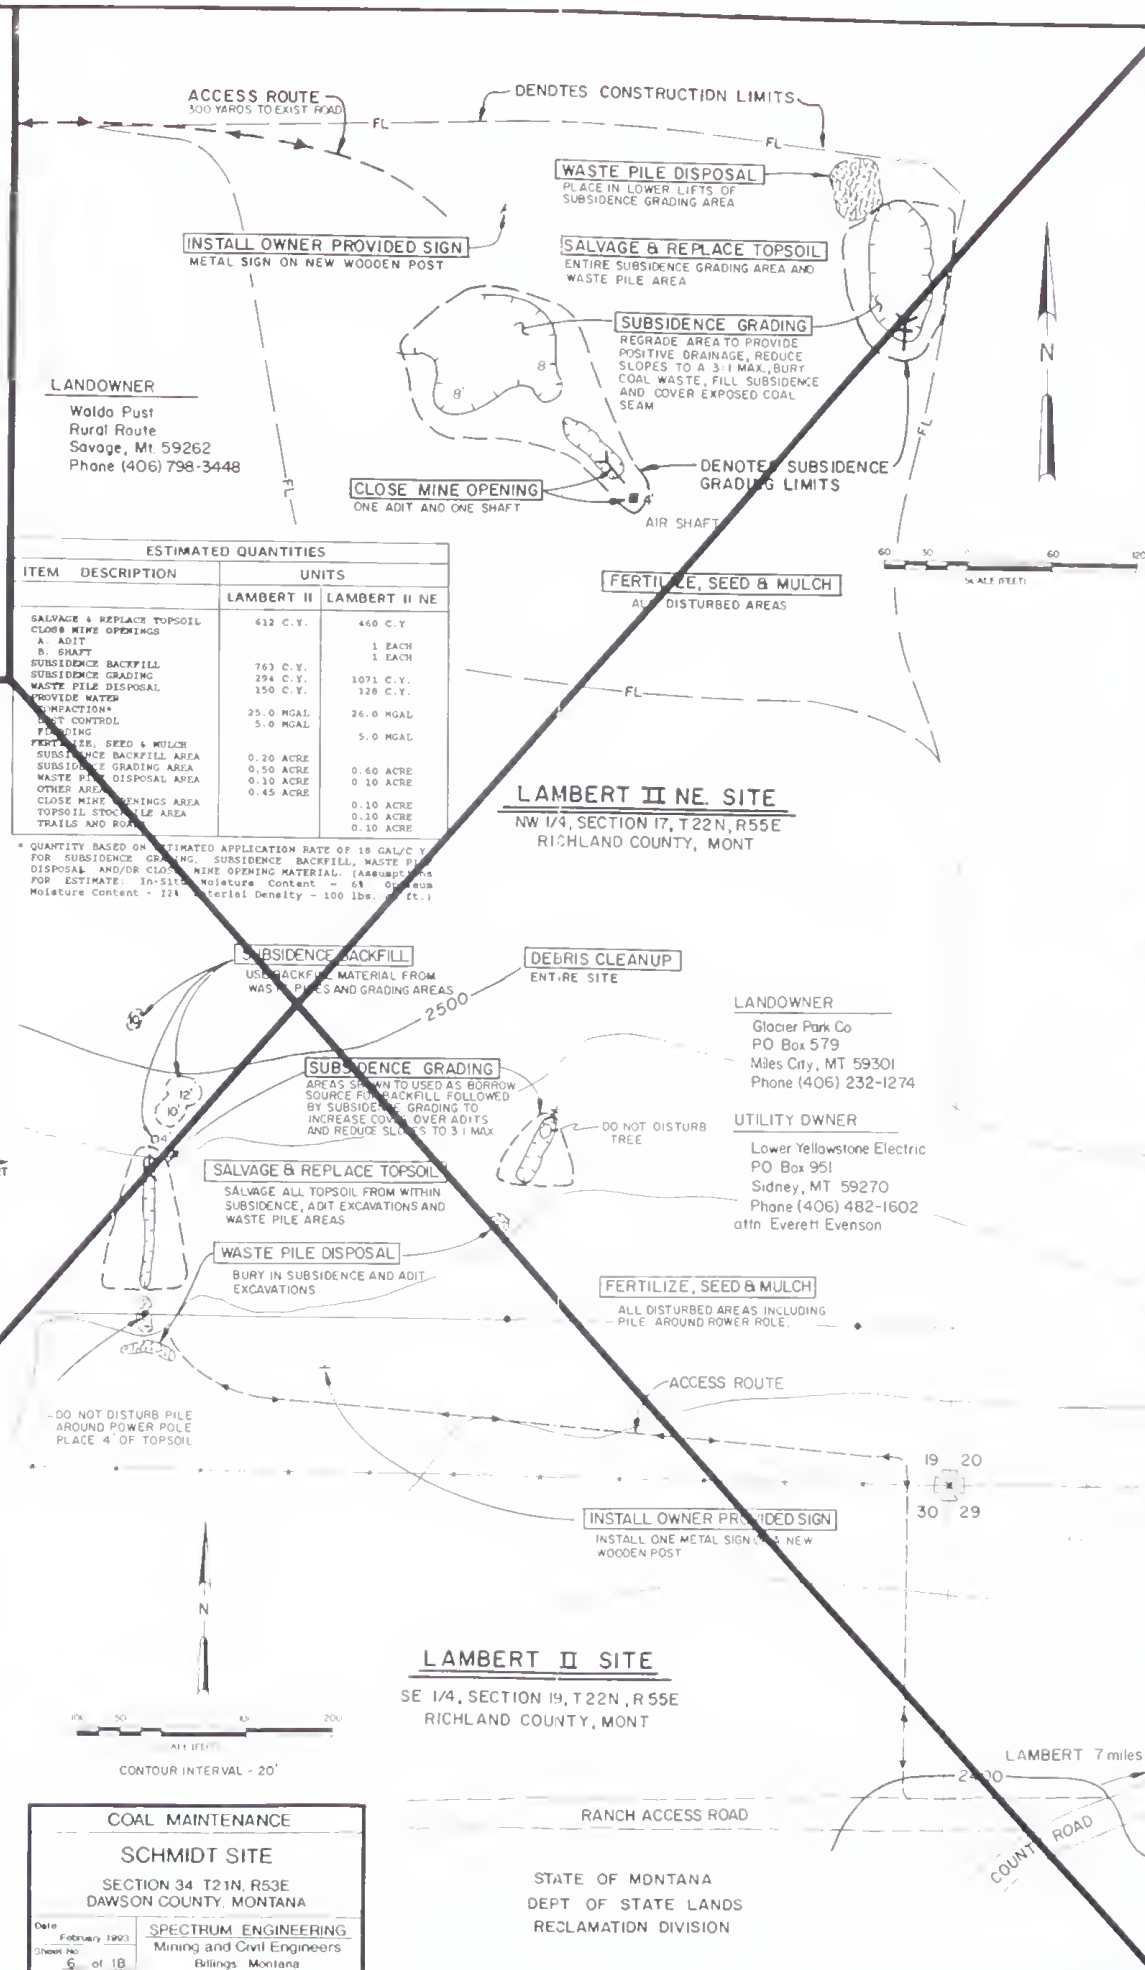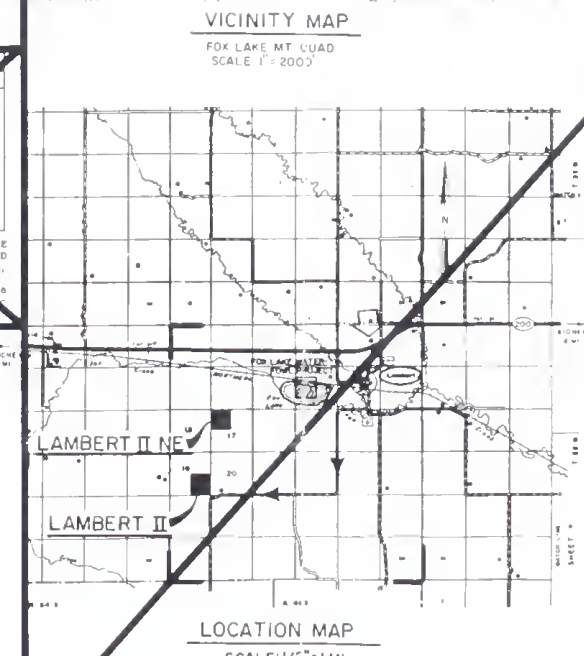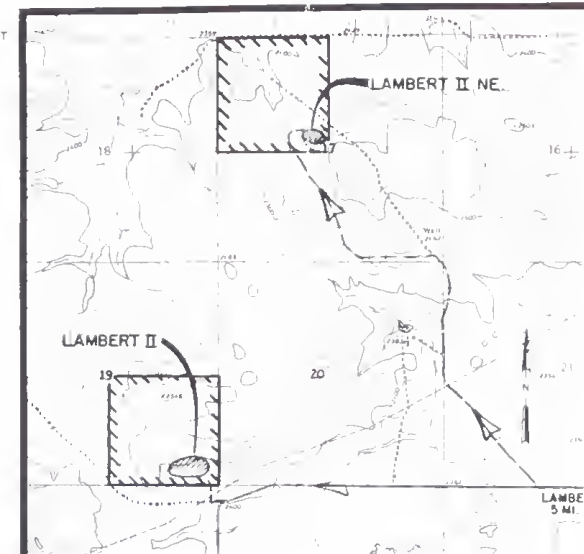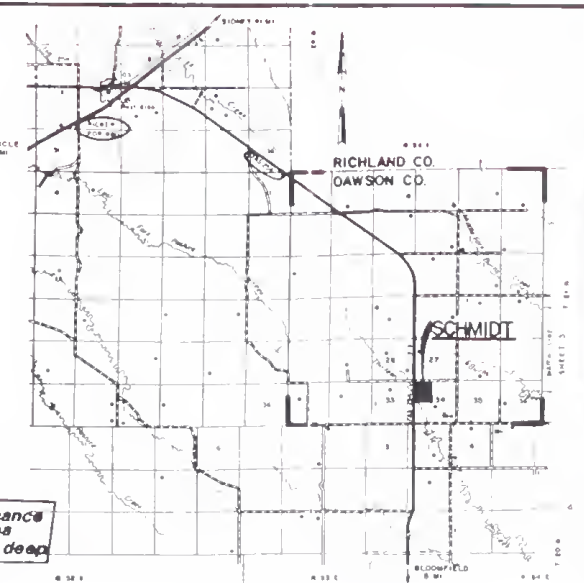L. C. Hanson Co.
CONSULTING, CIVIL, SANITARY, MUNICIPAL AND STRUCTURAL ENGINEERS
HELENA, MONTANA


SCHMIDT, LAMBERT II RECLAMATION PLAN
GENERAL LAYOUT AND SITE PLAN

PROJECT NAME: SCHMIDT, LAMBERT II RECLAMATION PLAN
SHEET TITLE: GENERAL LAYOUT AND SITE PLAN
DRAWN BY: LBP
CHECKED BY: TDK
2-1-88
APPROVED BY: [Signature]
DATE: 7/9/93
REVISER: [Signature]
SCALE: AS SHOWN
SHEET NO. 5

**AS-BUILT DRAWING
AND PHOTO INDEX**

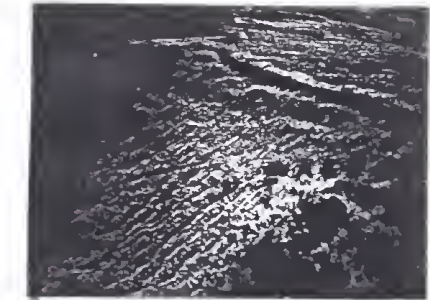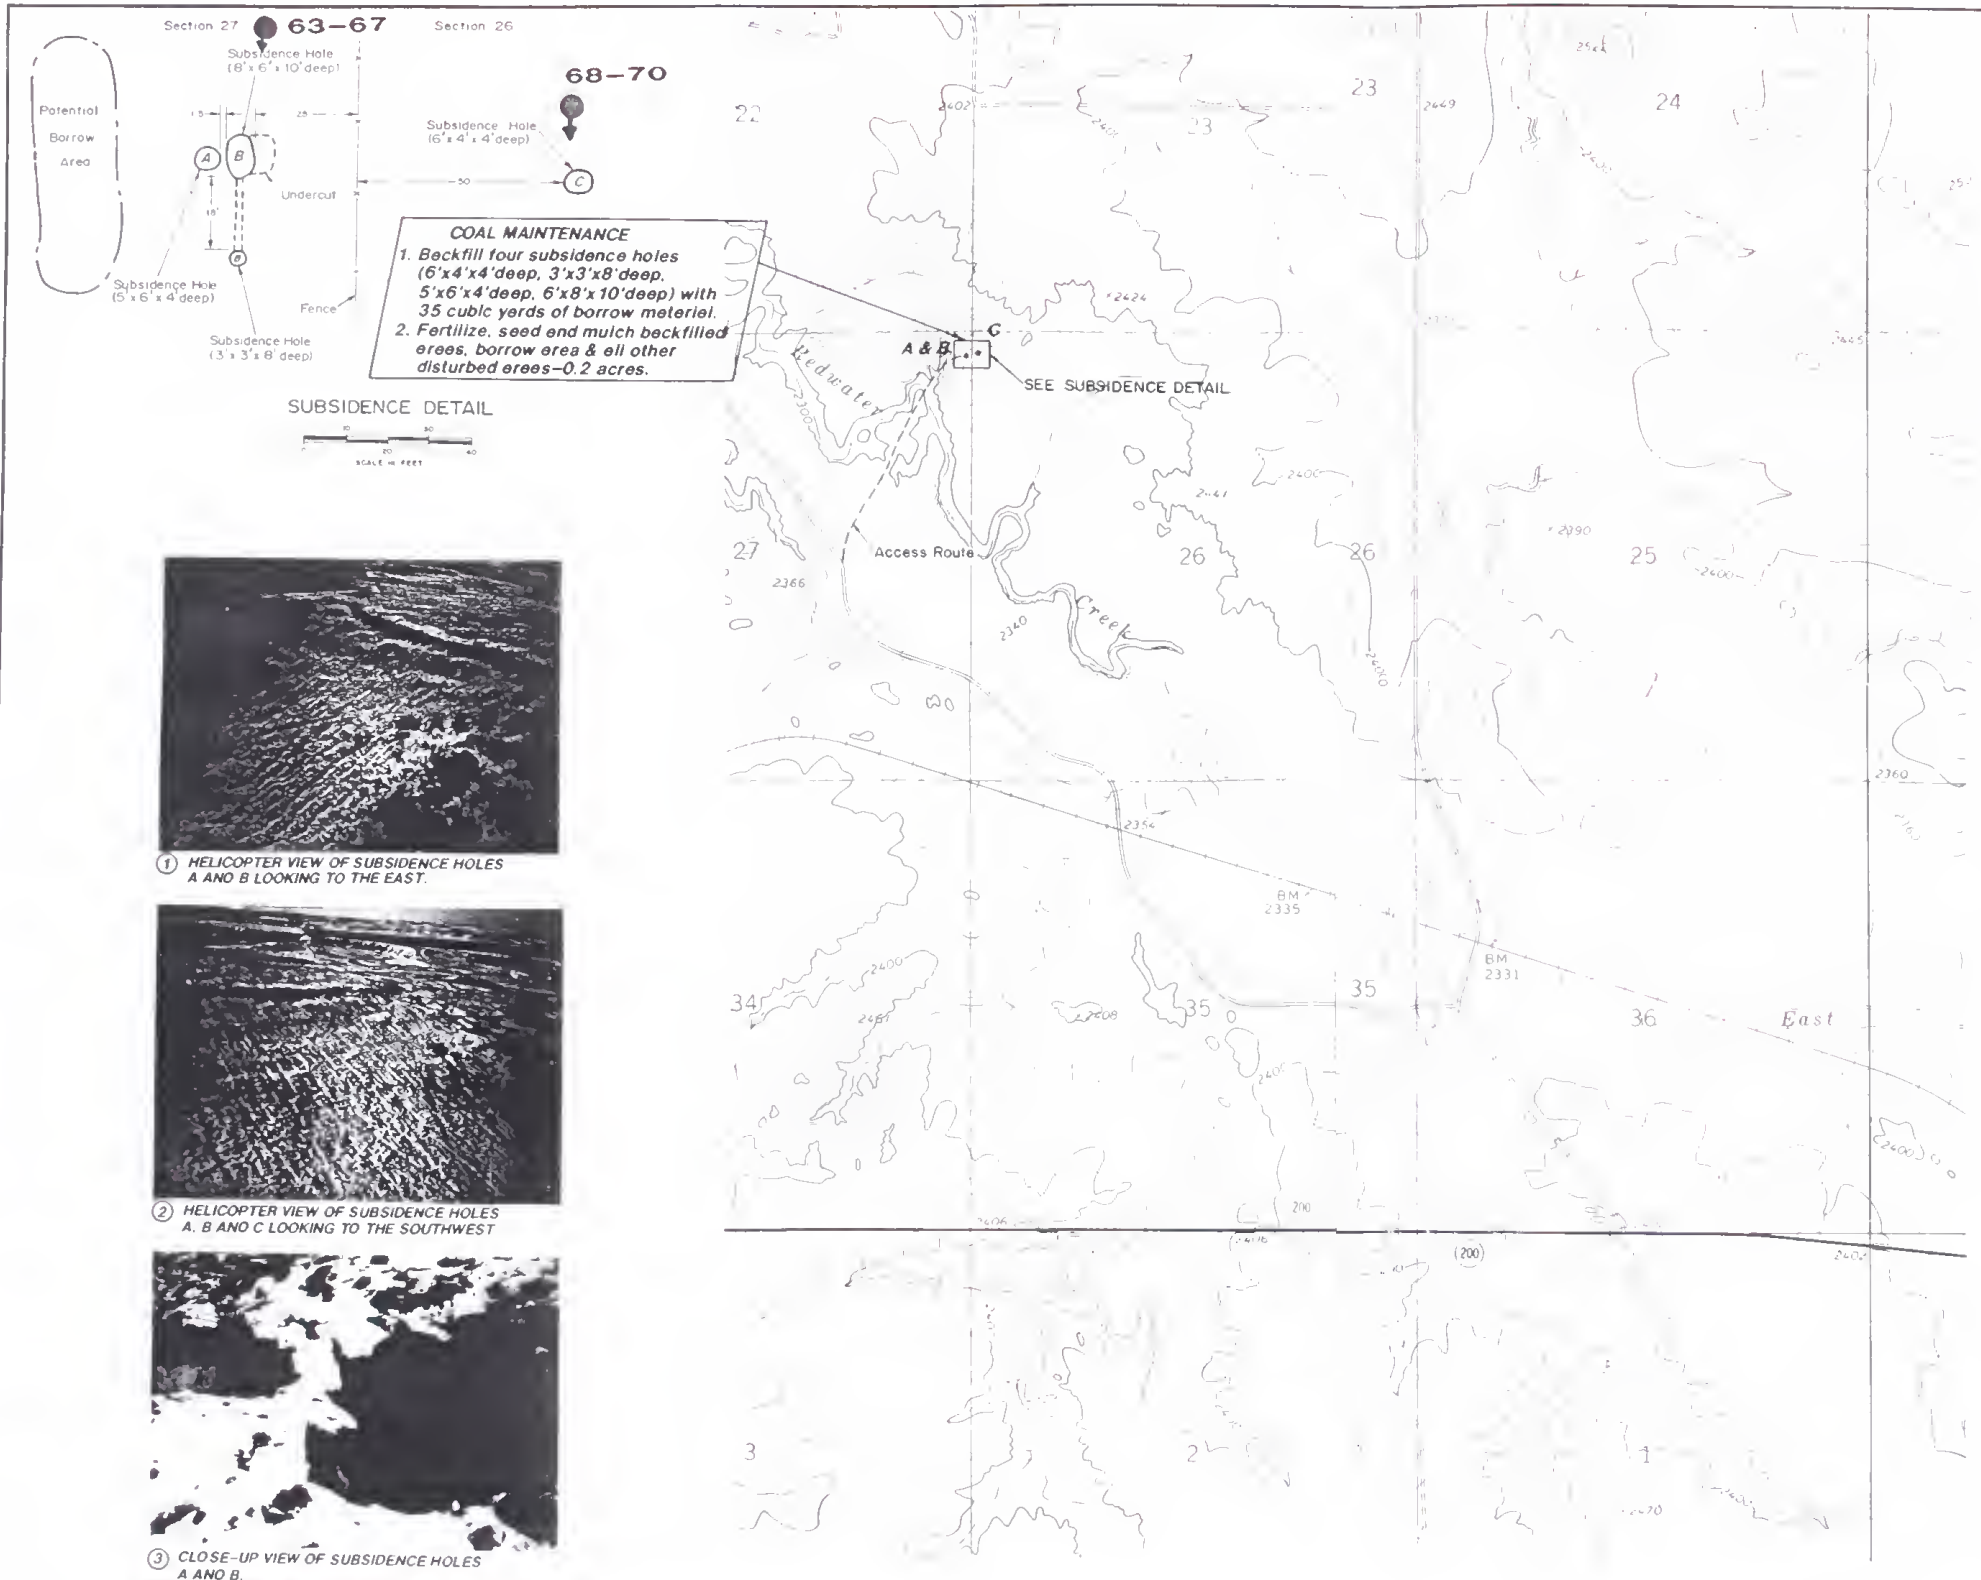


1 HELICOPTER VIEW OF SUBSIDENCE HOLES A AND B LOOKING TO THE EAST.

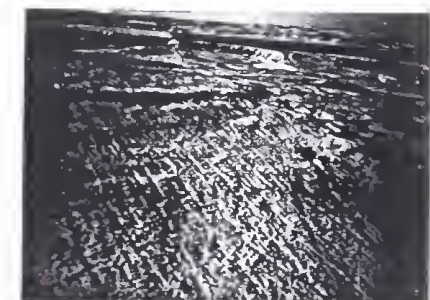

2 HELICOPTER VIEW OF SUBSIDENCE HOLES A, B AND C LOOKING TO THE SOUTHWEST.



3 CLOSE-UP VIEW OF SUBSIDENCE HOLES A AND B.

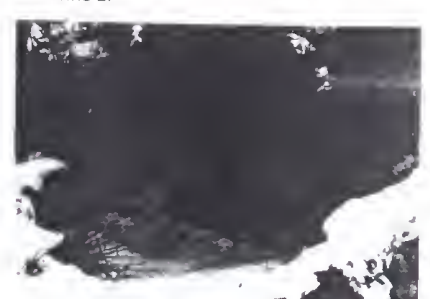

4 CLOSE-UP VIEW OF SUBSIDENCE HOLE C.

CONSTRUCTION IS LIMITED TO THE AREA SHOWN ON THIS TOPOGRAPHIC MAP



VEHICLE TRAVEL WILL BE LIMITED TO ROUTES FLAGGED ON-SITE BY THE PROJECT ENGINEER

LANDOWNER AND CONTACT
NW 1/4 NW 1/4 SECTION 26

RHINES FARMING CORP
HAROLD RHINES
BOX 19
SIDNEY, MT 59270
PHONE: (406) 774-3465
482-3750

LANDOWNER AND CONTACT
NE 1/4 NE 1/4 SECTION 27

TIM BOUCHARD
ROUTE 2 BOX 2366
SIDNEY, MT 59270
PHONE: (406) 482-4125

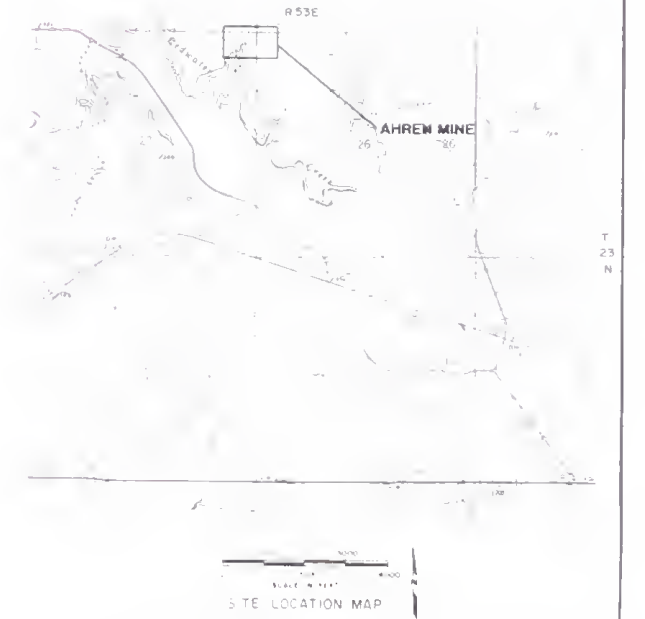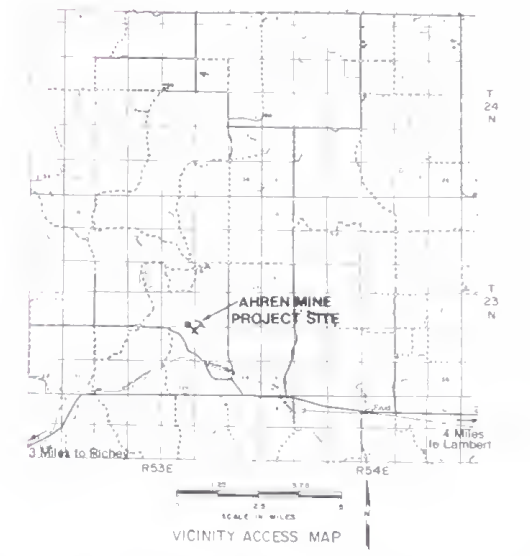

COAL MAINTENANCE	
AHREN MINE SITE	
SECTIONS 26 & 27 T23N R53E RICHLAND COUNTY MONTANA	
STATE OF MONTANA DEPARTMENT OF STATE LANDS ABANDONED MINE RECLAMATION BUREAU RECLAMATION DIVISION	
SPECTRUM ENGINEERING Mining and Civil Engineers 1415 4TH AVE NORTH BILLINGS, MONTANA	
DATE February 1993	REVISIONS BY DATE

AS-BUILT DRAWING
AND PHOTO INDEX

12-17

12-18

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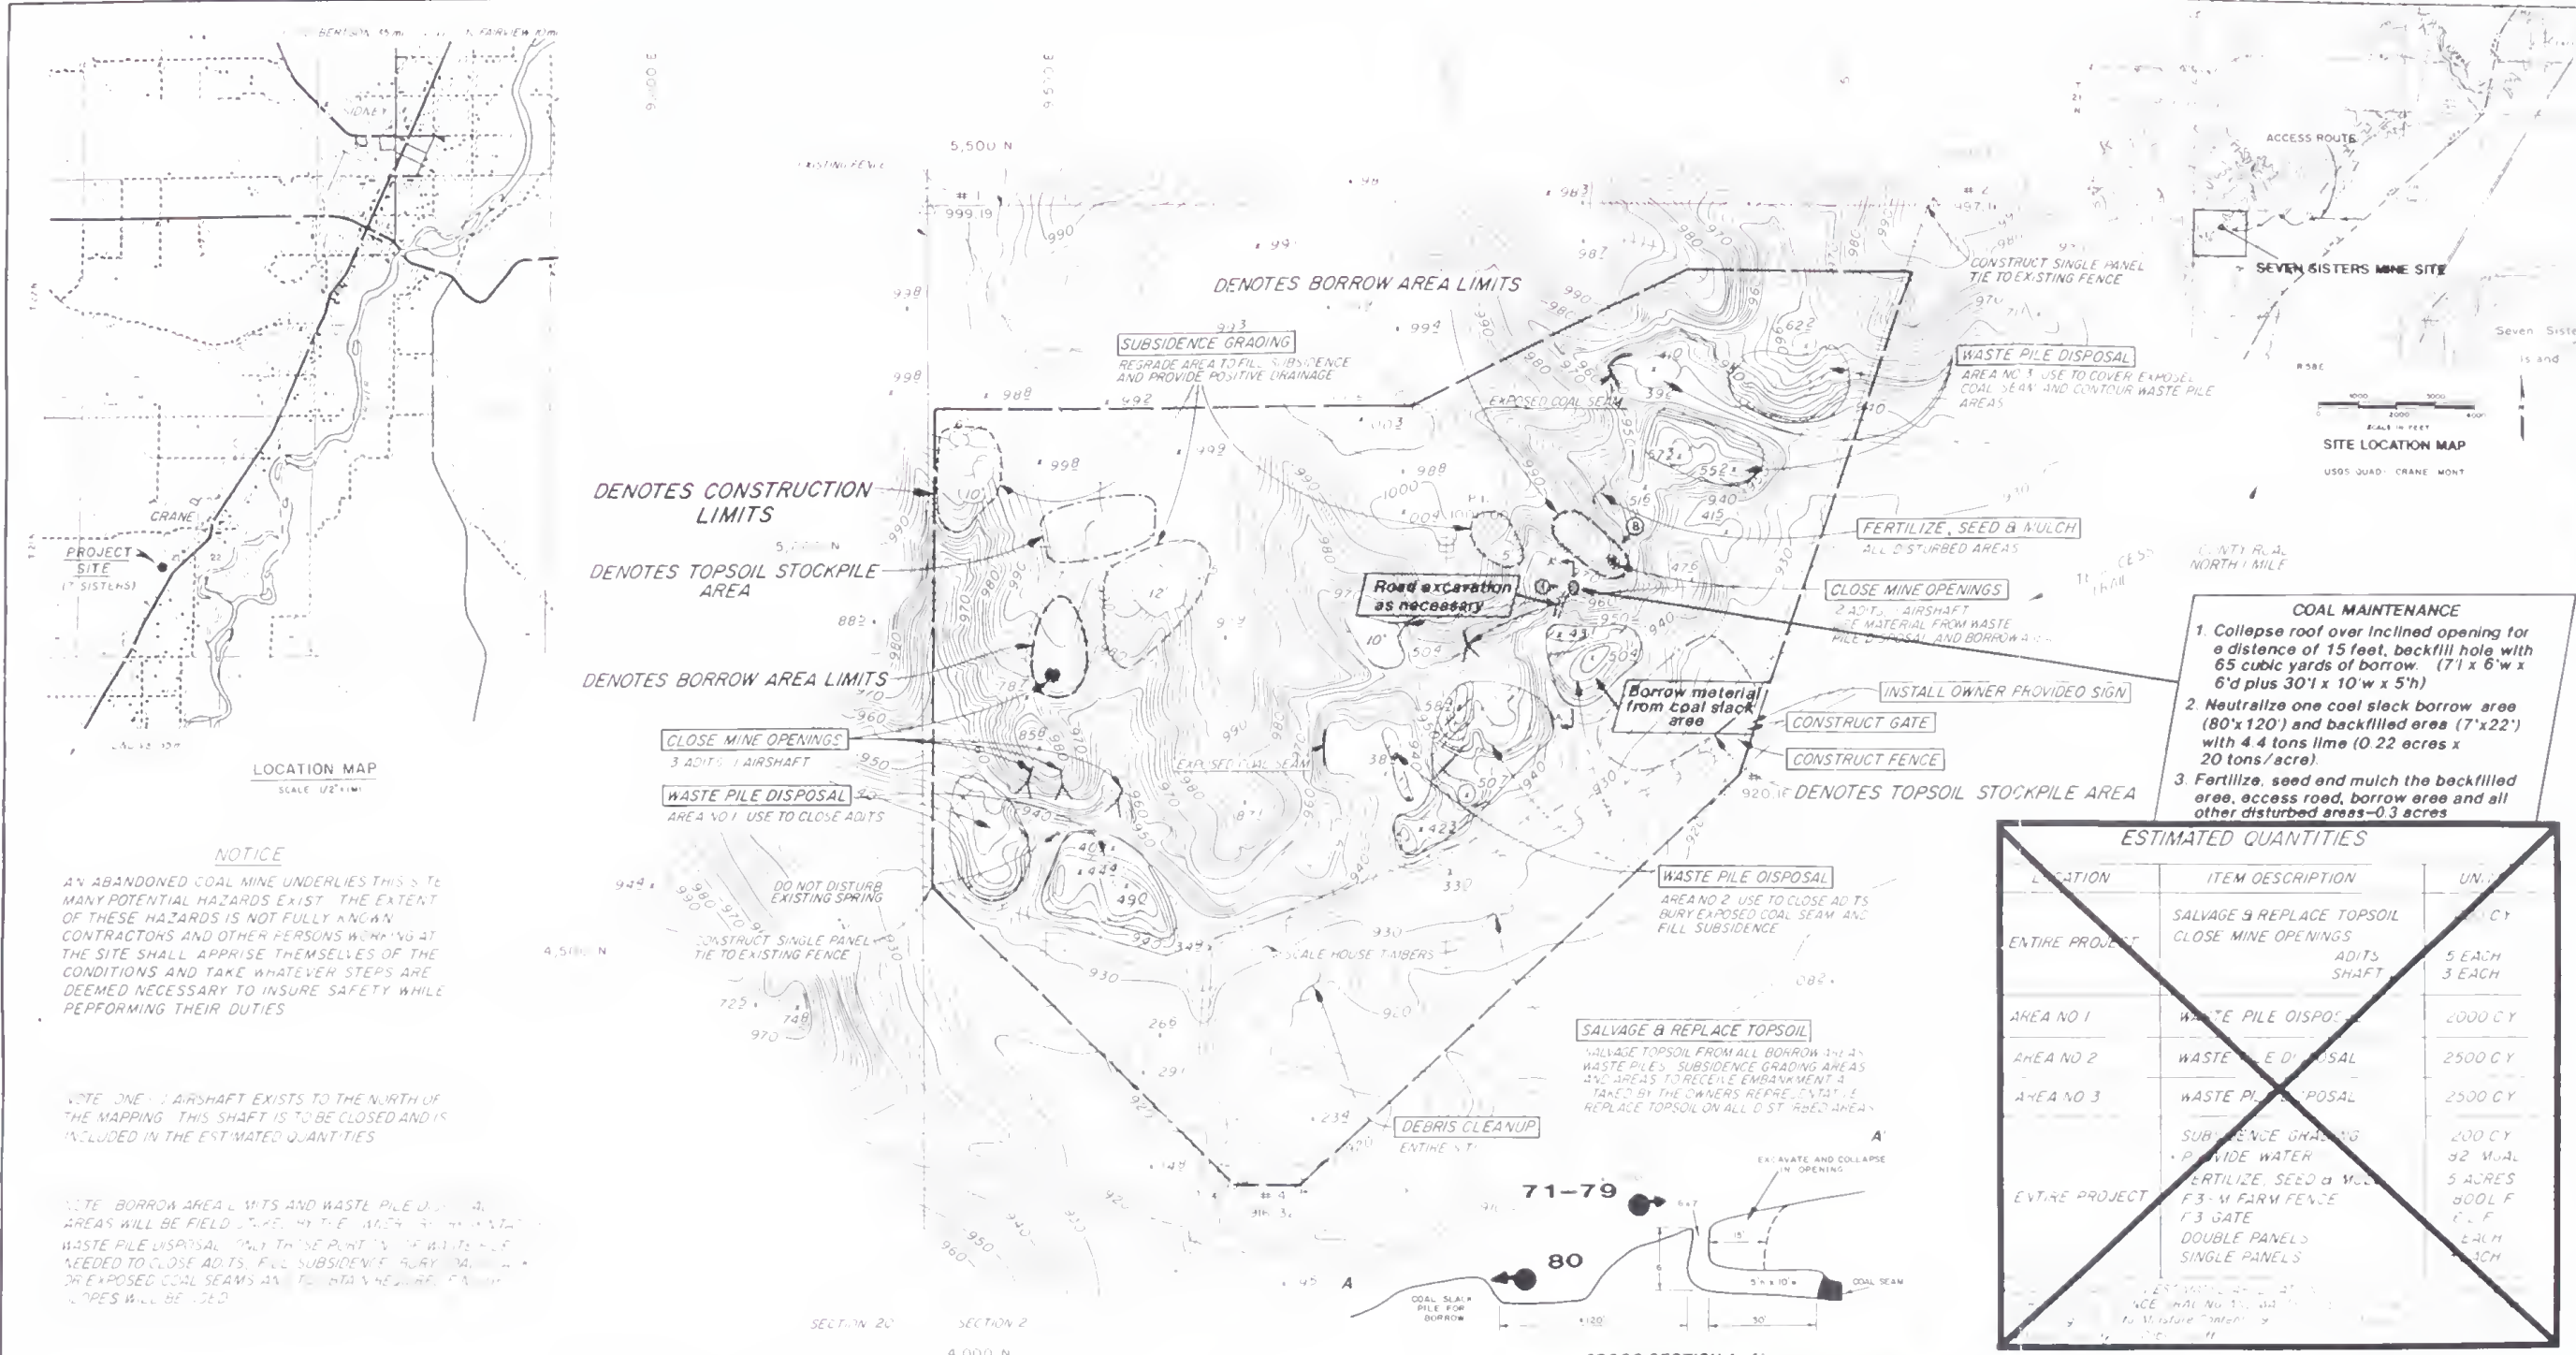
12-29

12-30

12-31

12-32





NOTICE
AN ABANDONED COAL MINE UNDERLIES THIS SITE. MANY POTENTIAL HAZARDS EXIST. THE EXTENT OF THESE HAZARDS IS NOT FULLY KNOWN. CONTRACTORS AND OTHER PERSONS WORKING AT THE SITE SHALL APPRISE THEMSELVES OF THE CONDITIONS AND TAKE WHATEVER STEPS ARE DEEMED NECESSARY TO INSURE SAFETY WHILE PERFORMING THEIR DUTIES.

NOTE: ONE AIRSHAFTE EXISTS TO THE NORTH OF THE MAPPING. THIS SHAFT IS TO BE CLOSED AND IS INCLUDED IN THE ESTIMATED QUANTITIES.



NOTE: BORROW AREA LIMITS AND WASTE PILE DISPOSAL AREAS WILL BE FIELD LINED BY THE AREA ENGINEER. WASTE PILE DISPOSAL AREAS THOSE PORTION OF WASTE PILES NEEDED TO CLOSE ADITS, FILL SUBSIDENCE BURY EXPOSED COAL SEAMS AND TO STABILIZE EROSION. SLOPES WILL BE USED.

N	NORTH	EAST	ELEV
1	4,122.91	1,441.71	1,140.42
2	4,122.95	1,441.71	1,140.38
3	4,122.86	1,441.71	1,140.38
4	4,122.42	1,441.71	1,140.54
5	4,122.25	1,441.71	1,140.91

LANDOWNER CONTACT PERSON
Greg Wyman
PO Box 3
Crane, Montana 59217
Phone (406) 482-683

LANDOWNER CONTACT PERSON
Ed Clemmer
Rural Route
Crane, Montana 59217
Phone (406) 798-3417


CONSTRUCTION PHOTOS

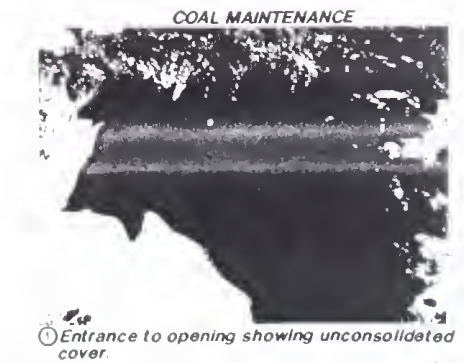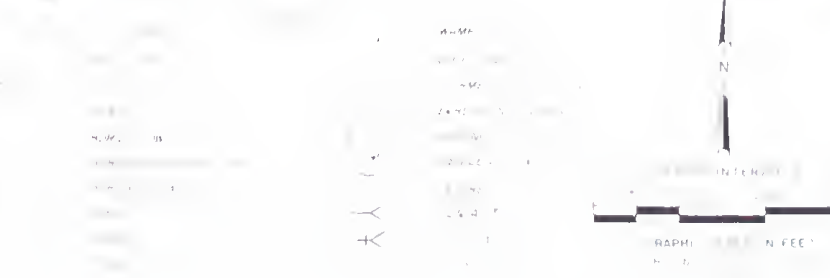

ESTIMATED QUANTITIES		
LOCATION	ITEM DESCRIPTION	UNITS
ENTIRE PROJECT	SALVAGE & REPLACE TOPSOIL	2000 CY
	CLOSE MINE OPENINGS	5 EACH
	ADITS	3 EACH
AREA NO 1	WASTE PILE DISPOSAL	2000 CY
AREA NO 2	WASTE PILE DISPOSAL	2500 CY
AREA NO 3	WASTE PILE DISPOSAL	2500 CY
ENTIRE PROJECT	SUBSIDENCE GRADING	200 CY
	PROVIDE WATER	52 GAL
	FERTILIZE, SEED & MULCH	5 ACRES
	1/2" X 1/2" FARM FENCE	800 L.F.
	1/2" GATE	1 EACH
	DOUBLE PANELS	1 EACH
	SINGLE PANELS	1 EACH

SEVEN SISTERS MINE
SECTION 21, T21N R58E
RICHLAND COUNTY, MONTANA
ASSOCIATED SURVEYS
1981 & 1982
BILLINGS, MONTANA

COAL MAINTENANCE
SEVEN SISTERS MINE
SECTION 21, T21N R58E
RICHLAND COUNTY MONTANA
SPECTRUM ENGINEERING
Mining and Civil Engineers
Billings, Montana
February 1993
Sheet No. 6 of 18

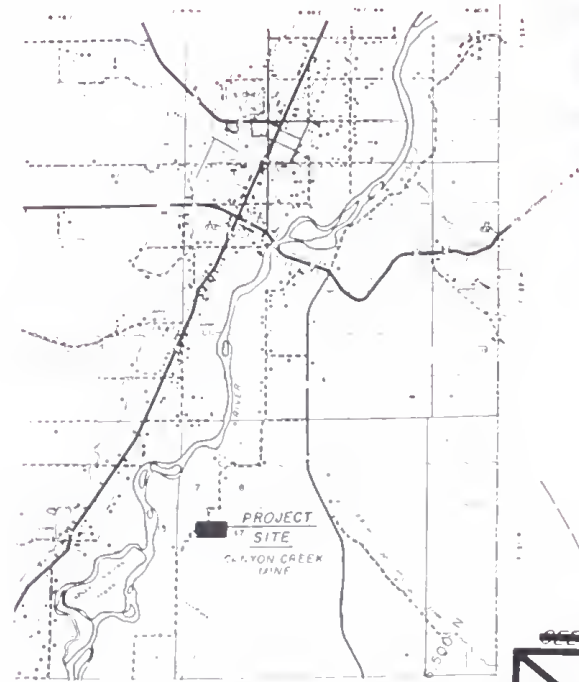

LOCATION MAP
SCALE 1" = 1 MI

SHEET 1
SHEET 2
MATCH LINE

NOTE ACCESS TO BE FIELD STAKED


LANDOWNER

ALL SEC 17 & E 1/2 NE 1/4 & S 1/2 SEC 18


TOD V & SUSAN L. GORDER
PO BOX 4054, SKAAR ROUTE
SIDNEY, MT. 59270
PHONE (406)482-2254

NO	NORTH	EAST	ELEV
P1	5,000.00	10,000.00	1000.00
1	4,564.07	10,479.46	988.17
2	5,706.05	10,755.77	904.55
3	6,342.22	9,799.73	936.87
4	6,776.44	8,961.16	900.15
5	7,697.82	8,154.16	908.05
6	5,744.02	8,788.88	932.18

Grid North Based on Hammer Beams
Vertical Datum Based on A. used Elevation
Fixed by A. C. P. and C. P. Survey
Produced July 14, 1993 and September 11,
1993 By Montana Department of State Lands
Topography Prepared by: K. H. H. Camera
50 MM. Distagon Lens. Aerial Photography
1:1000 - July 14, 1993 with Lens Cor-
rection Applied. This is a copy. Has Not
Been Field Checked.
Associated Surveyors Inc. Billings, Montana

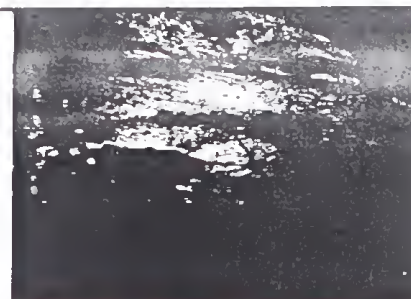



Picture 1 shows the 3 subsidence holes.

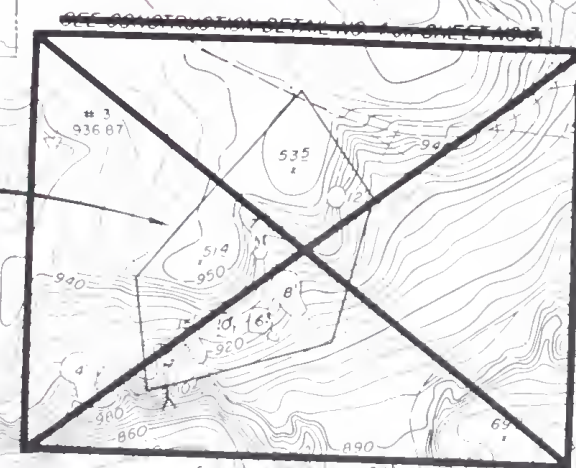


- LEGEND
- PAVED ROAD
 - IMPROVED ROAD
 - TRAIL
 - BRIDGE
 - CATTLE GUARD
 - CULVERT
 - FENCE
 - RAILROAD
 - POWER POLE
 - TREES
 - DRAINAGE
 - POND
 - SWAMP
 - INDEX CONTOUR
 - INTERMEDIATE CONTOUR
 - DEPRESSION CONTOUR
 - BUILDING
 - DEPTH OF SUBSIDENCE

CONSTRUCTION PHOTOS

81-91

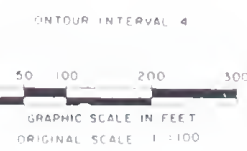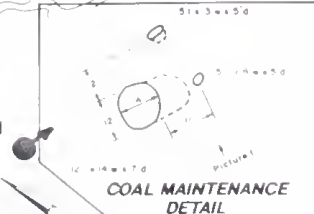

NOTICE
AN ABANDONED COAL MINE UNDERLIES THIS SITE. MANY POTENTIAL HAZARDS EXIST. THE EXTENT OF THESE HAZARDS IS NOT FULLY KNOWN. CONTRACTORS AND OTHER PERSONS WORKING AT THE SITE SHALL APPRISE THEMSELVES OF THE CONDITIONS AND TAKE WHATEVER STEPS ARE DEEMED NECESSARY TO INSURE SAFETY WHILE PERFORMING THEIR DUTIES.

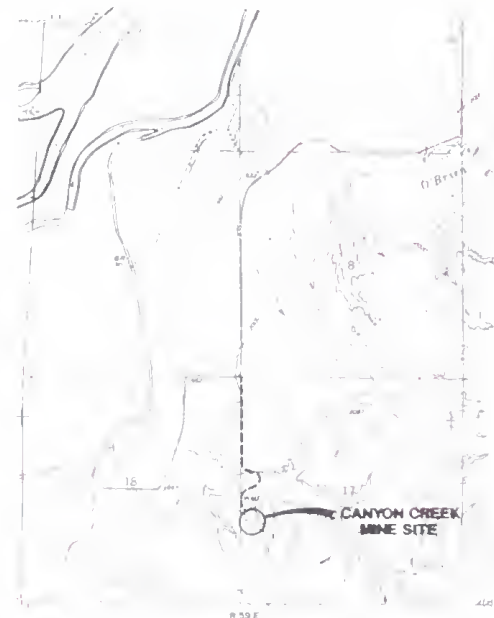

SITE LOCATION MAP

- COAL MAINTENANCE
- Backfill 3 subsidence holes (12' x 14' w x 7' d, 5' x 8' w x 5' d, and 5' x 3' w x 5' d plus undercuts) with 70 cubic yards of borrow material.
 - Salvage and replace 6" cover soil from borrow area (30 cubic yards).
 - Fertilize, seed and mulch backfilled areas, borrow sites & all other disturbed areas-0.2 acres.

COAL MAINTENANCE
CANYON CREEK MINE SITE
SECTION 17, T21N, R59E
RICHLAND COUNTY, MONTANA

Date: February 1993
Sheet No: 18

SPECTRUM ENGINEERING
Mining and Civil Engineers
Billings, Montana

STATE OF MONTANA
DEPT. OF STATE LANDS
RECLAMATION DIVISION

CANYON CREEK MINE
SEC 17 & 18, T21N, R59E
RICHLAND COUNTY, MONTANA


ASSOCIATED SURVEYS INC.
land & aerial
BILLINGS, MONTANA



L. C. Hanson Co.
CONSULTING, CIVIL, SANITARY, MUNICIPAL AND STRUCTURAL ENGINEERS
HELENA, MONTANA

CANYON CREEK MINE - RECLAMATION PLAN
SITE PLAN AND GENERAL LAYOUT

PROJECT NAME: CANYON CREEK MINE - RECLAMATION PLAN
SHEET TITLE: SITE PLAN AND GENERAL LAYOUT
DRAWN BY: AR
CHECKED BY: TDX 6/18/93
APPROVED BY: J. H. H.
DATE: 6/18/93
REVISED: 8-1-85
SCALE: 1" = 100'
SHEET NO: 2 OF 4
PROJECT NO: 84-10-04


AS-BUILT DRAWING
AND PHOTO INDEX

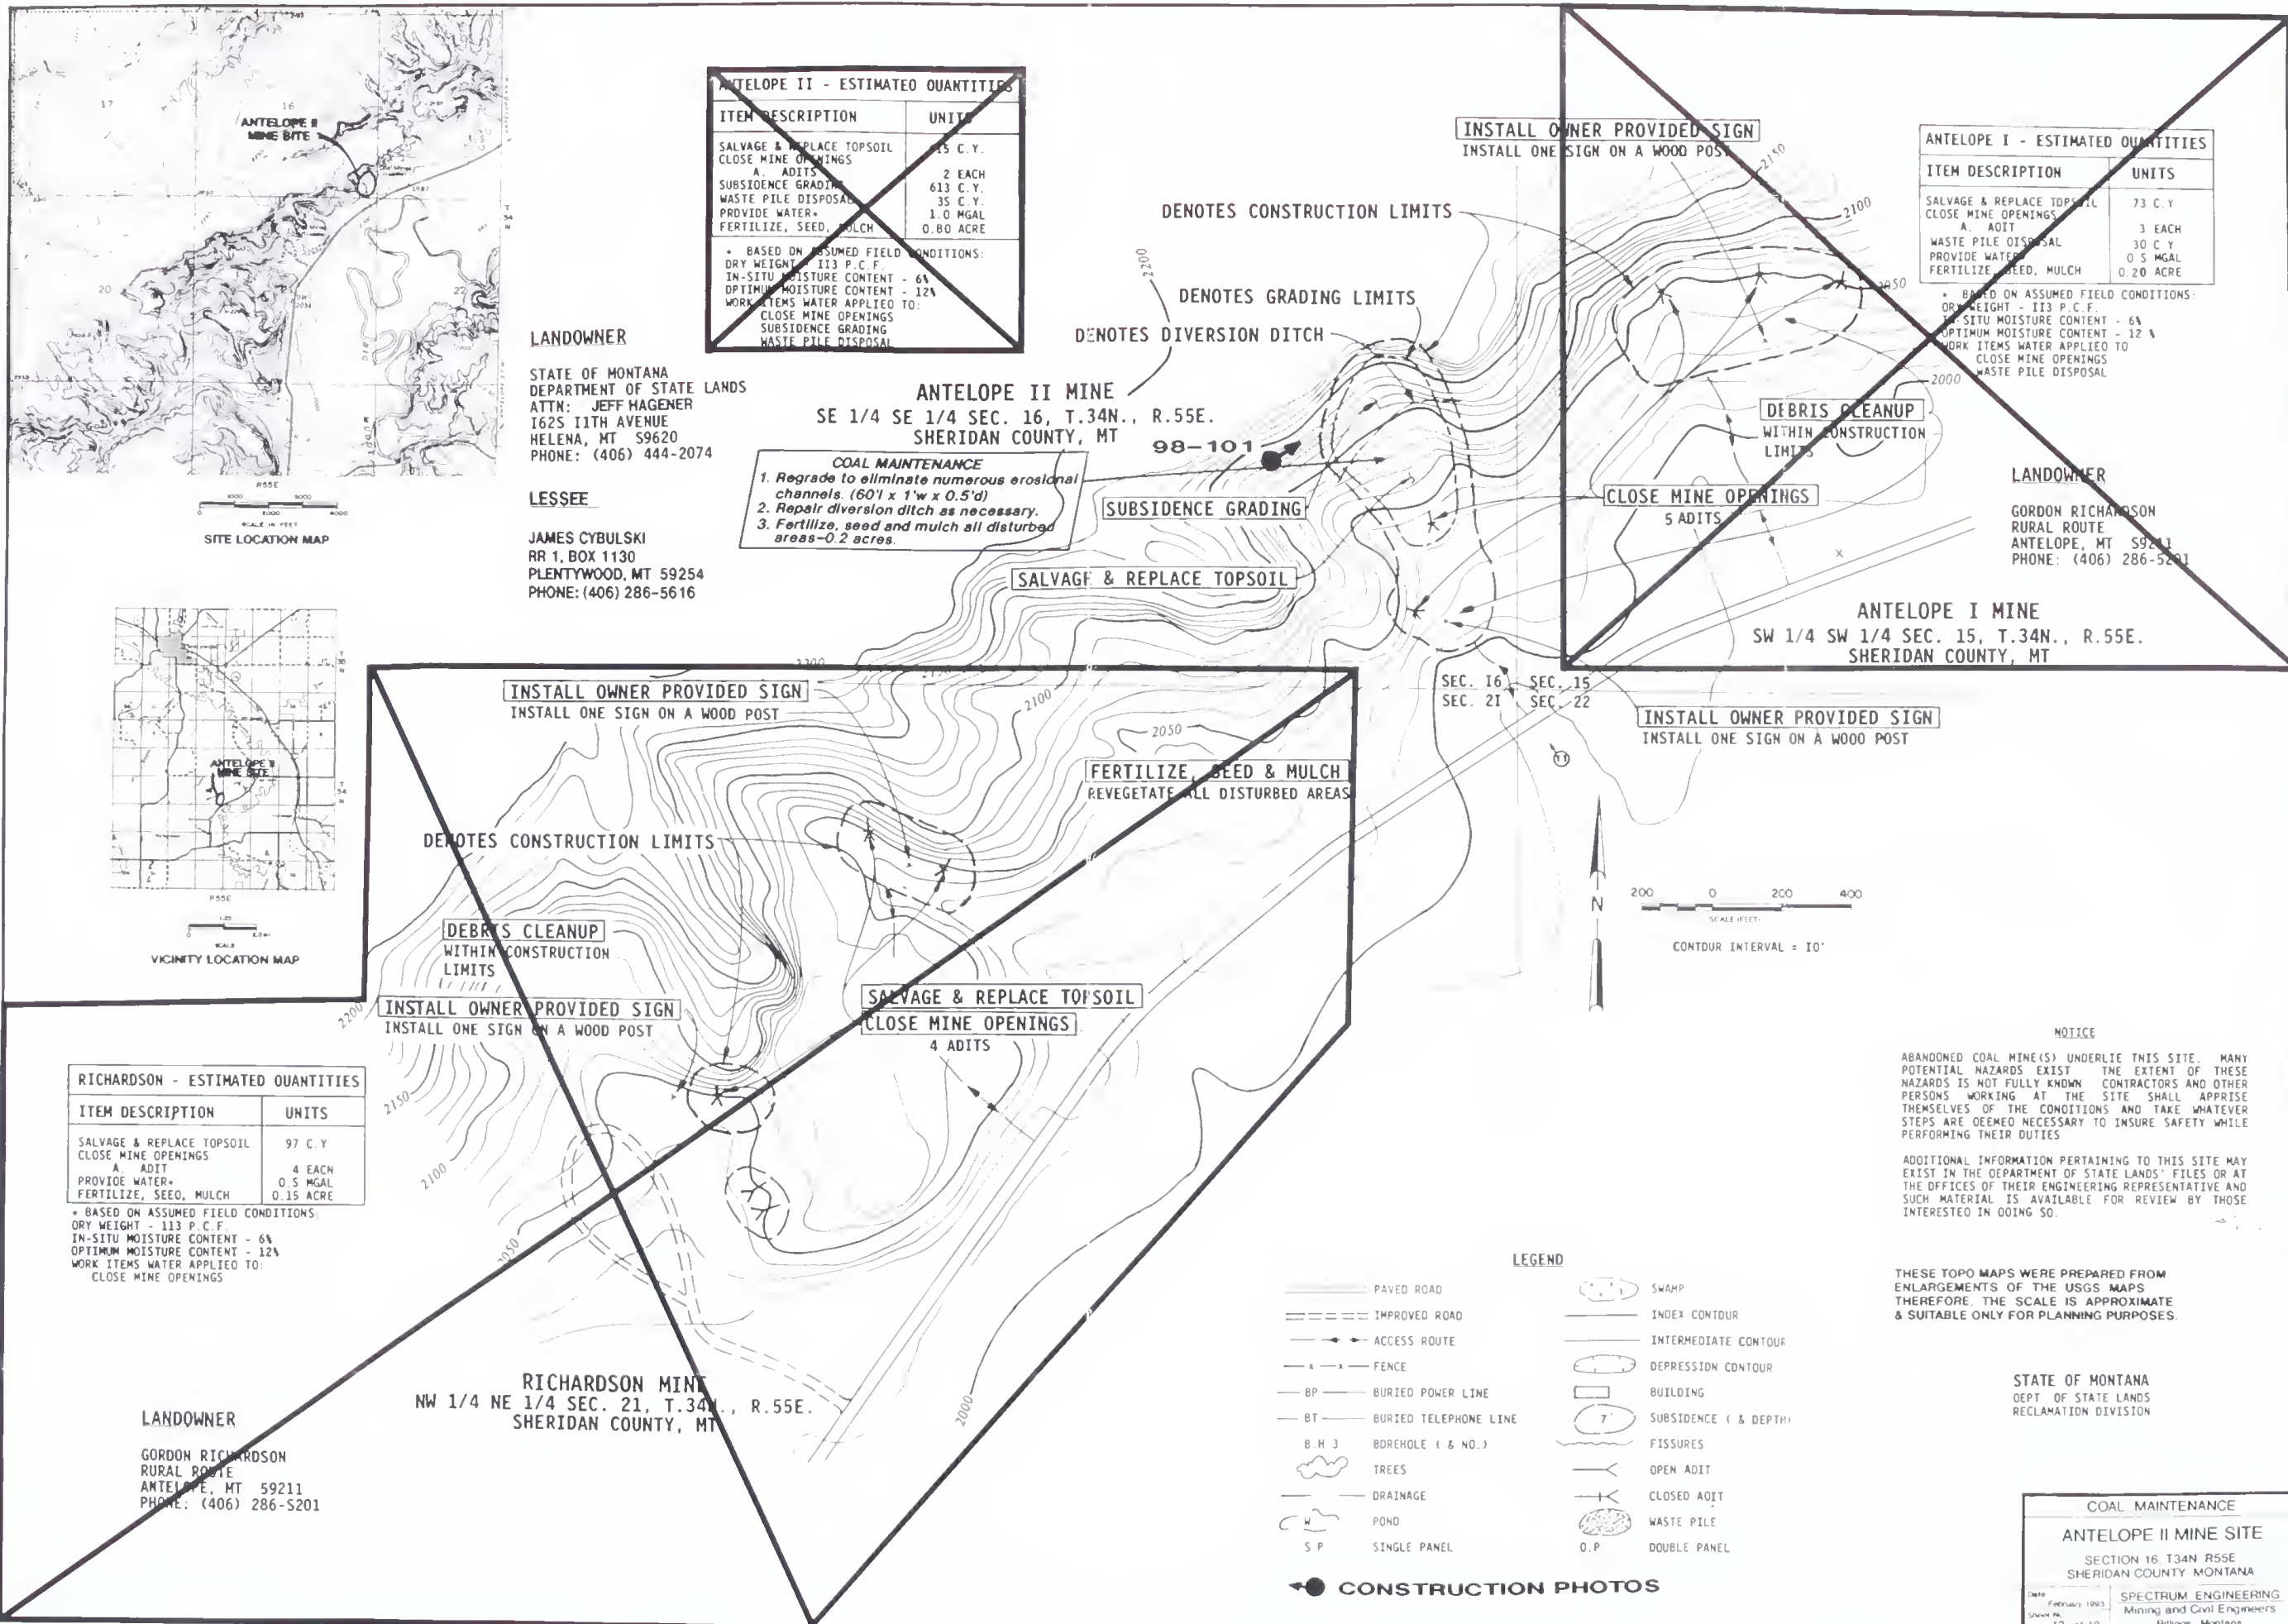

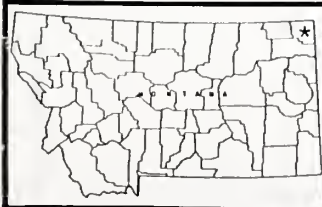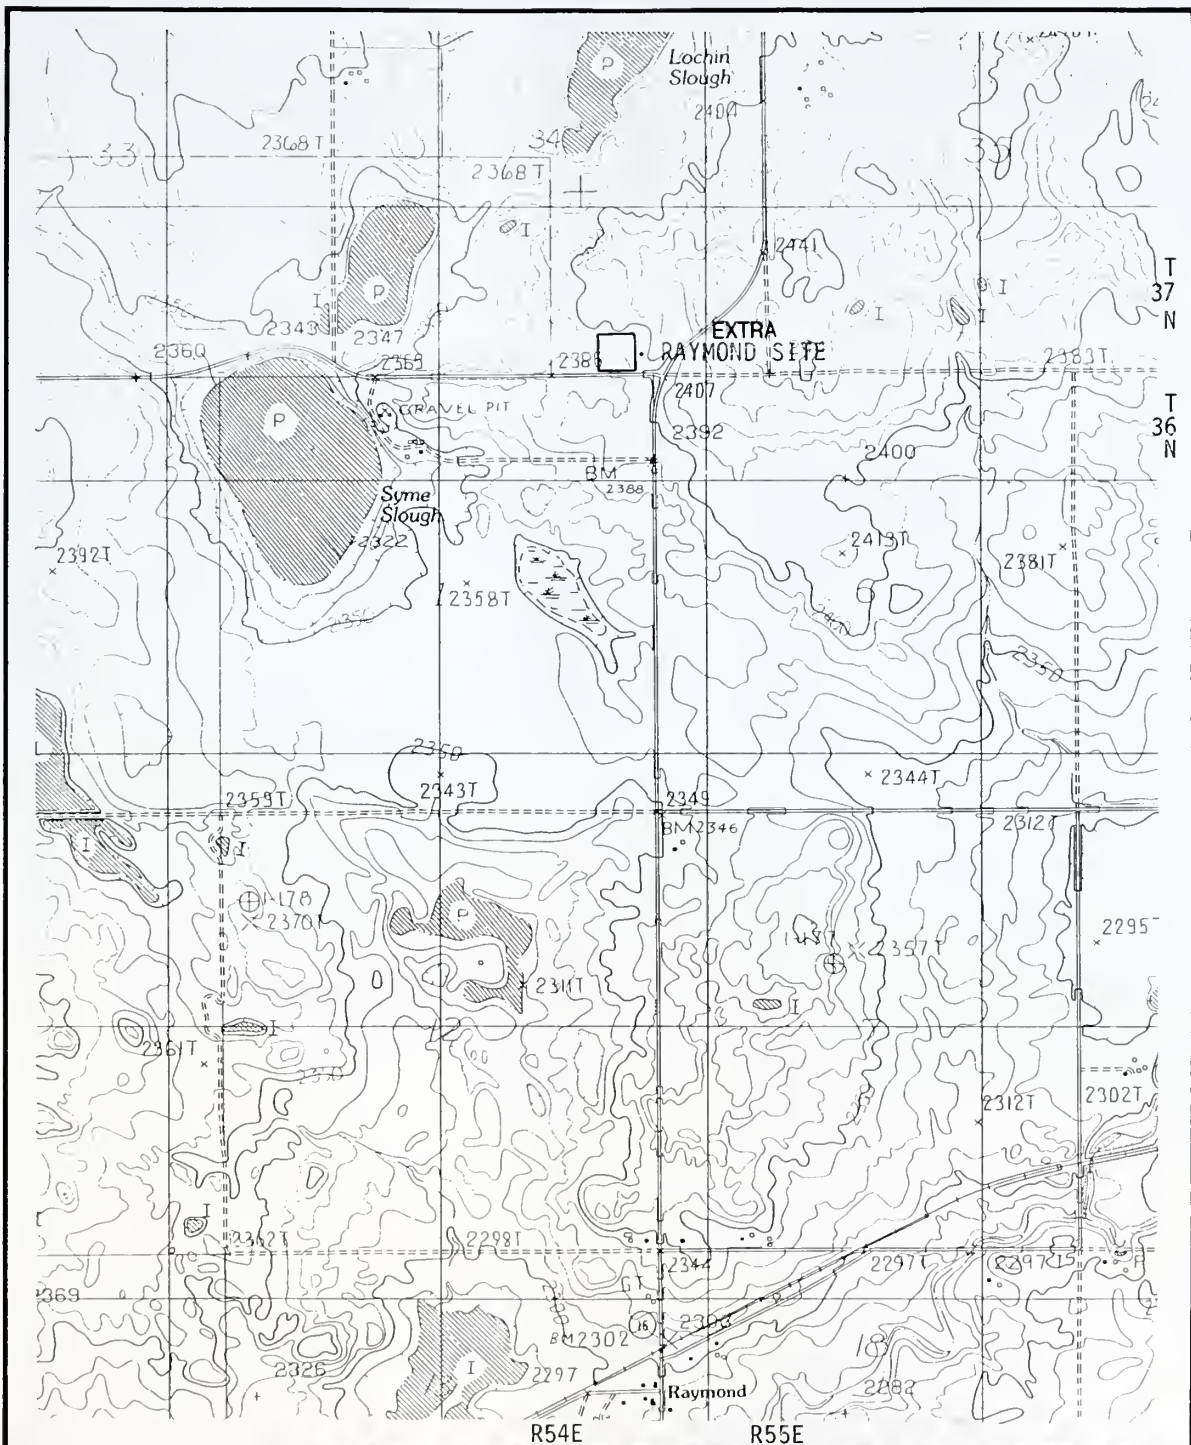

STATE OF MONTANA — DEPARTMENT OF STATE LANDS
 ABANDONED MINE RECLAMATION BUREAU—RECLAMATION DIVISION


SITE MAP
 SITE Raymond (Nick Lockin Mine)
 Sheridan COUNTY, MT; TOWNSHIP 37N RANGE 54E
 SECTION(S) 34 LATITUDE 48° 54.7' LONGITUDE 104° 34.9'
 MAP SCALE: 1" = 2000 U.S.G.S. QUAD SHEET Raymond

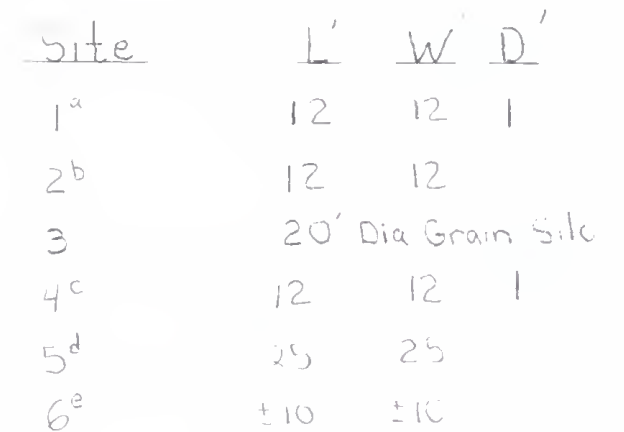

- a. Small concrete blocks present, supposedly site of main shaft
- b. Barren circular patch in grassy field. Owner said this hole has been filled.
- c. Slightly depressed area that owner has filled. Supposedly site of main shaft.
- d. Coal slacked area supposedly a shaft area, presently filled in.
- e. Owner claims a sinkhole use to exist here, presently filled in.
- f. Area is heavily overgrown in brush. Owner claims some sinkholes exist in this area, although none were found. Also, next door neighbor's (shown) sewer drain line in this area.

Date	Scale	Drawn
5/86	1" = 100'	n/a

COAL MAINTENANCE
EXTRA RAYMOND SITE

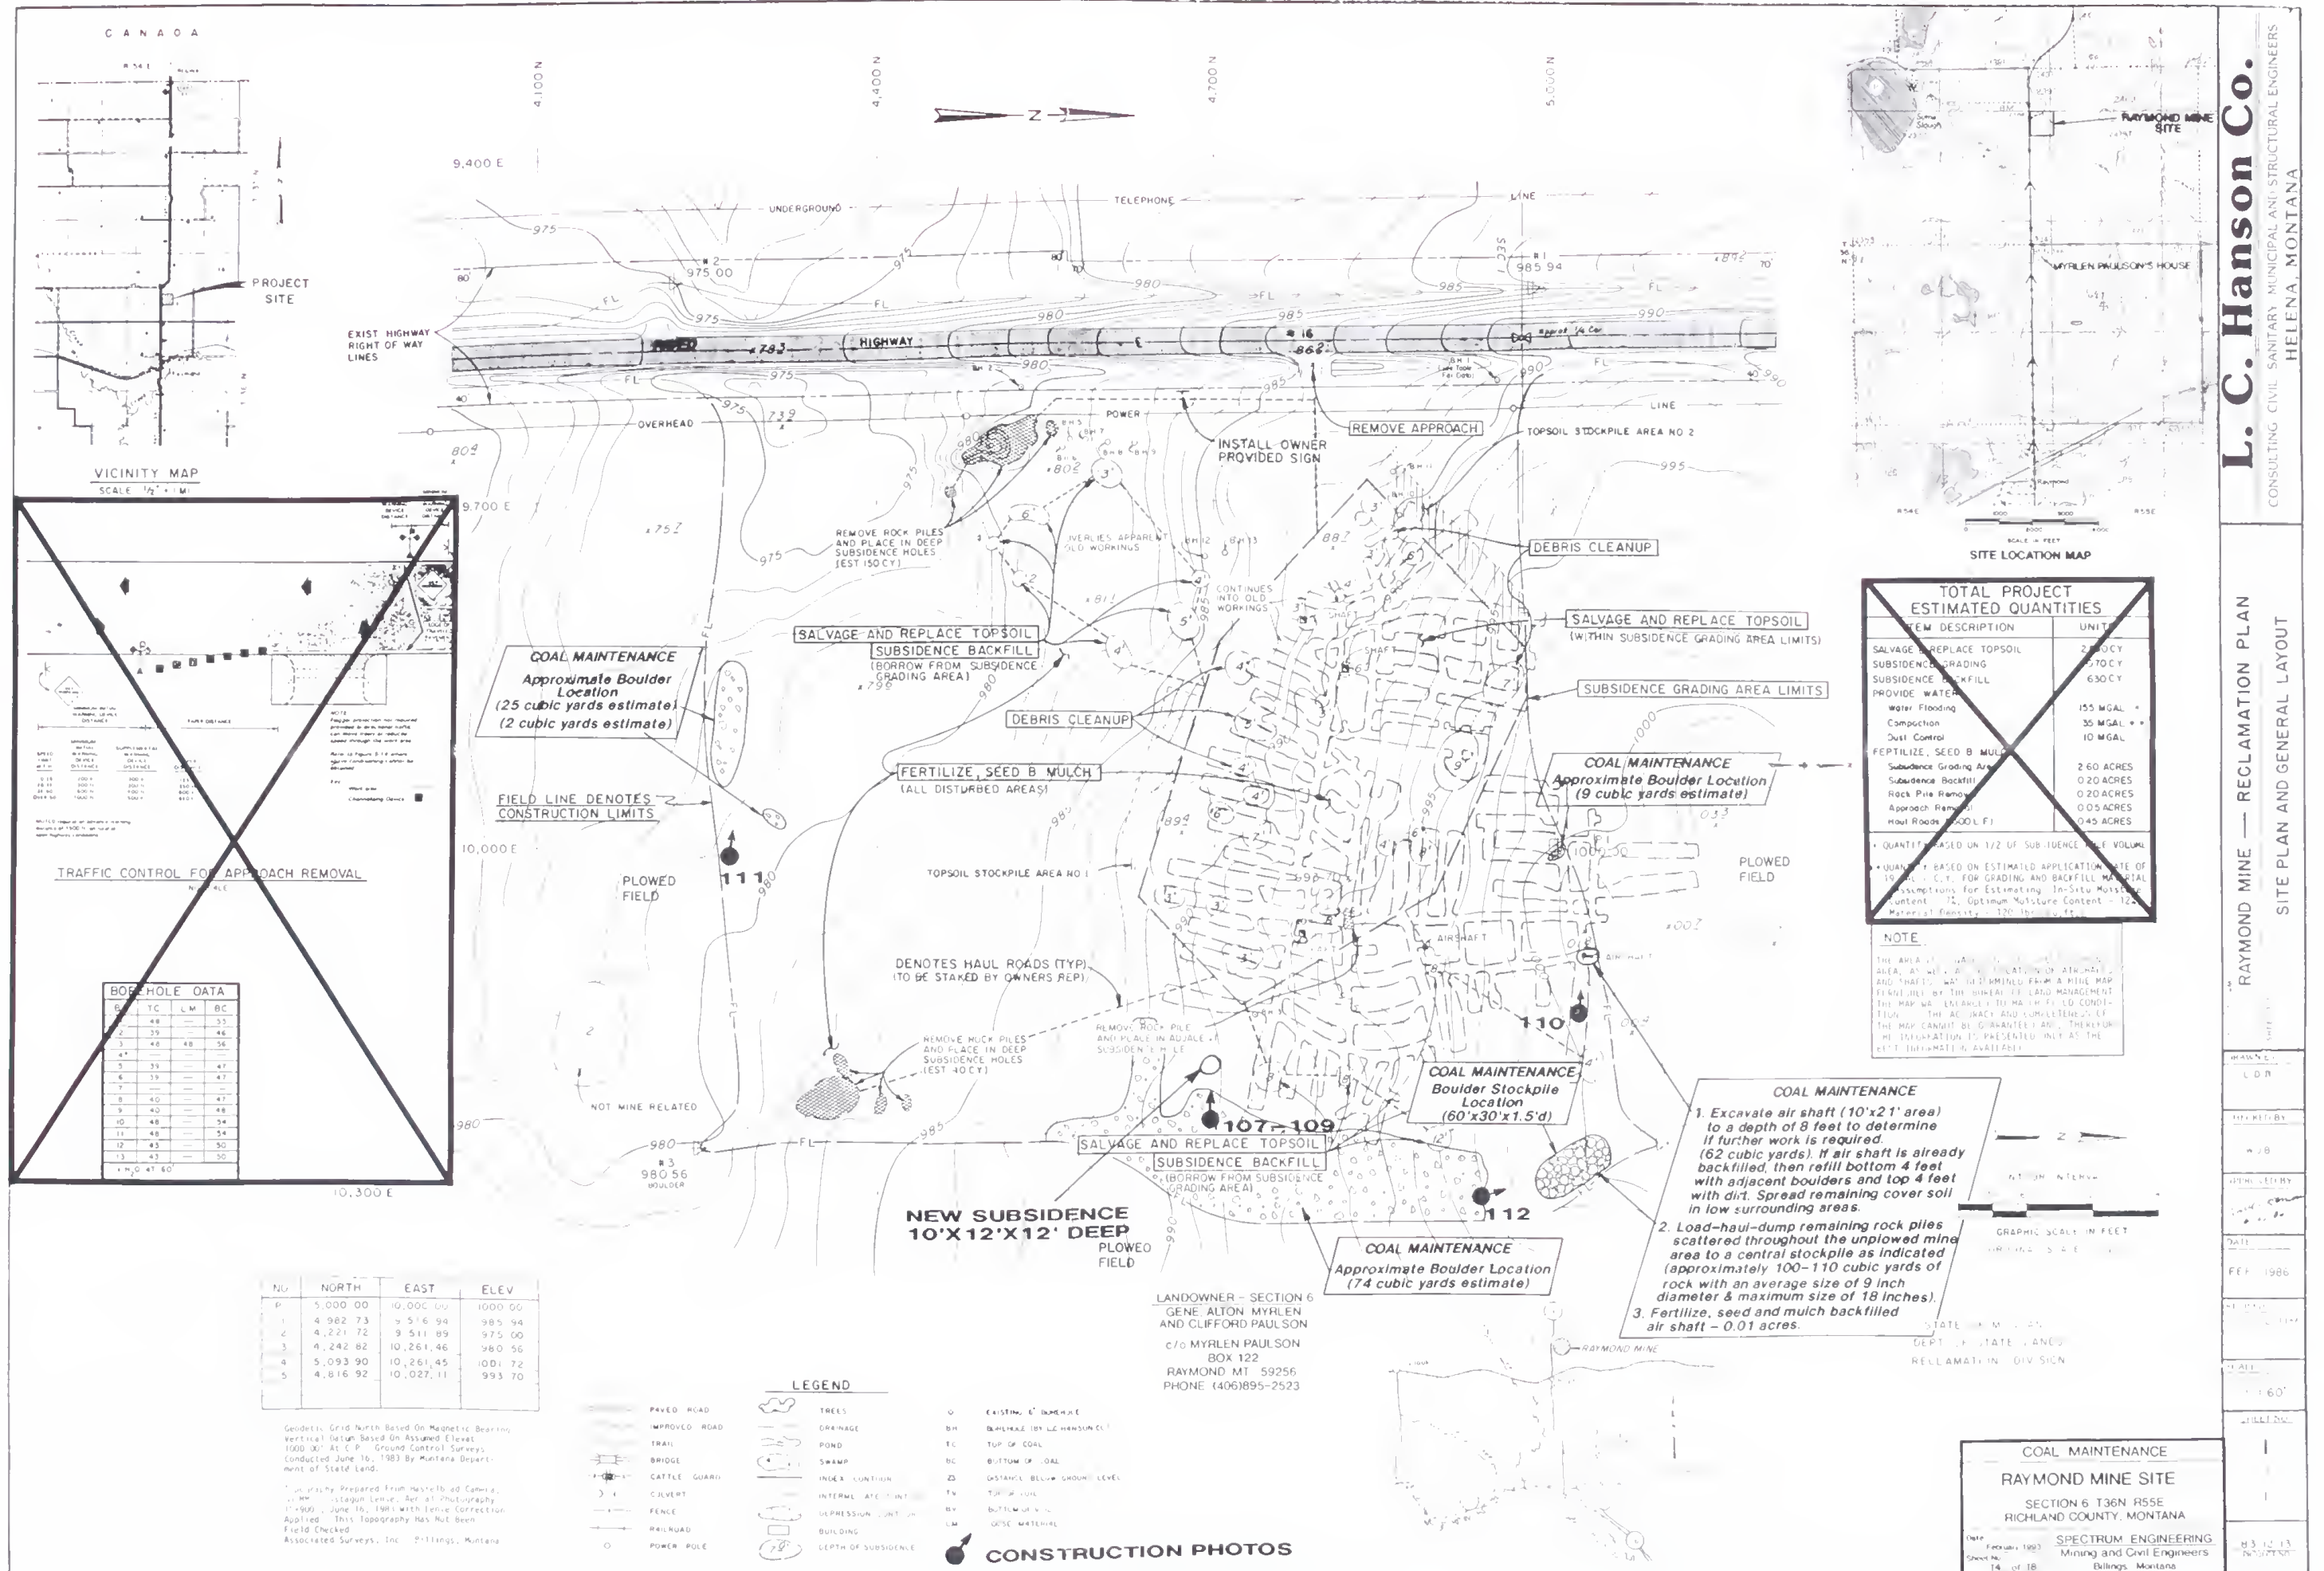



- LEGEND
- PAVED ROAD
 - IMPROVED ROAD
 - ACCESS ROUTE
 - FENCE
 - B.P. BURIED POWER LINE
 - B.T. BURIED TELEPHONE LINE
 - B.H.3 BOREHOLE (& NO.)
 - TREES
 - DRAINAGE
 - POND
 - S.P. SINGLE PANEL
 - SWAMP
 - INDEX CONTOUR
 - INTERMEDIATE CONTOUR
 - DEPRESSION CONTOUR
 - BUILDING
 - SUBSIDENCE (& DEPTH)
 - FISSURES
 - OPEN ADIT
 - CLOSED ADIT
 - WASTE PILE
 - D.P. DOUBLE PANEL

CONSTRUCTION PHOTOS

NIKOLAISEN - ESTIMATED QUANTITIES	
ITEM DESCRIPTION	UNITS
SALVAGE & REPLACE TOPSOIL	32 C.Y.
CLOSE MINE OPENINGS	
A. ADIT	2 EACH
SPECIAL GRADING	283 C.Y.
PROVIDE WATER	16.0 MGAL.
FERTILIZE, SEED & MULCH	0.6 ACRE
* BASED ON ASSUMED FIELD CONDITIONS: DRY WEIGHT - 113 P.C.F. IN-SITU MOISTURE CONTENT - 6% OPTIMUM MOISTURE CONTENT - 12% WORK ITEMS WATER APPLIED TO: CLOSE MINE OPENINGS, AND SPECIAL GRADING	






LANDOWNER

MARETTA RAMIREZ
(Lucille Stewart's Sister)
7508 E. McKNIGHT
SCOTTSDALE, AZ 85251
PHONE: UNLISTED

LANDOWNER

LUCILLE C. KING STEWART
15 ASH DRIVE
WAYBURN, SASKATCHEWAN S4H0R9
PHONE: (306) 842-8141
(Power of Attorney)

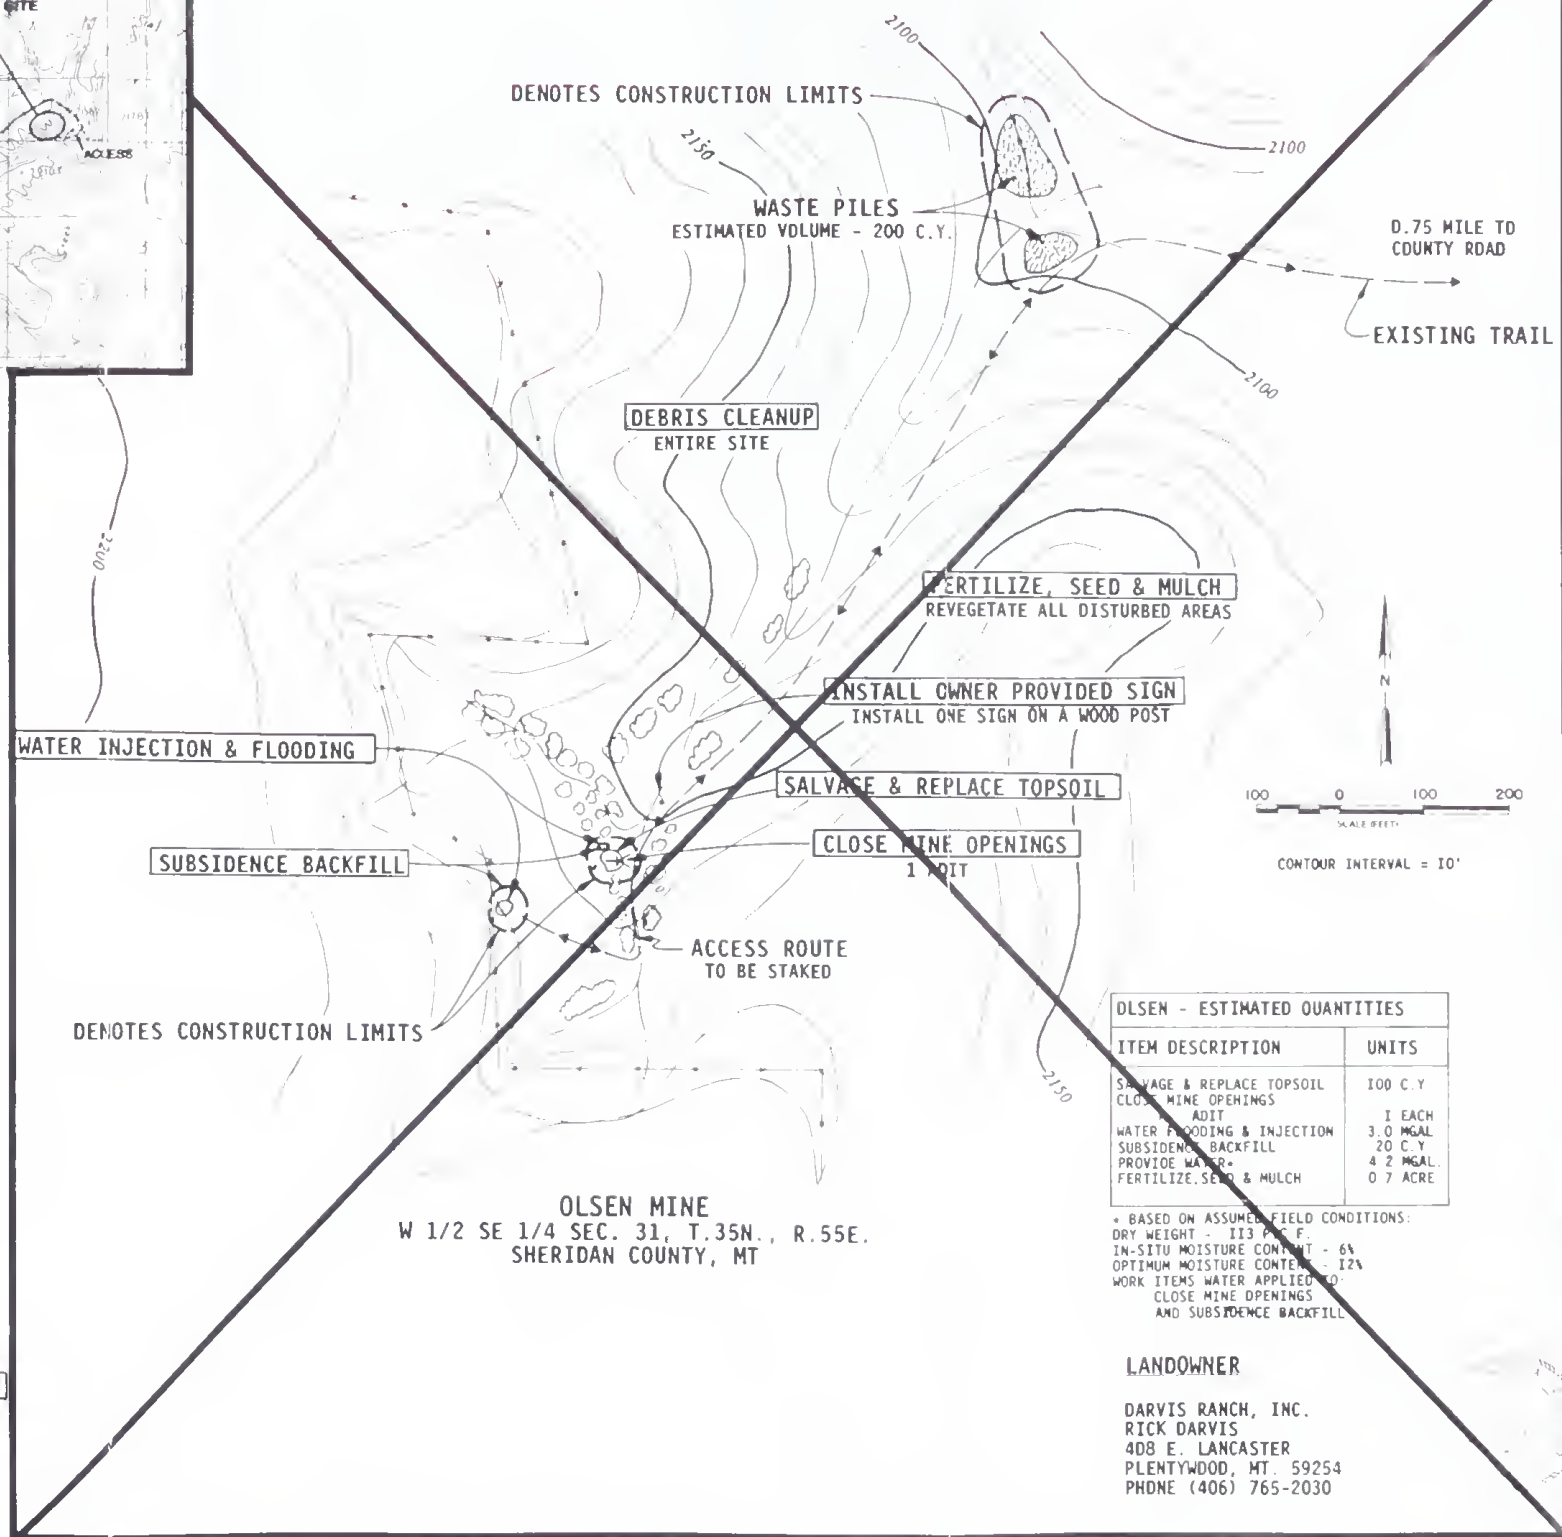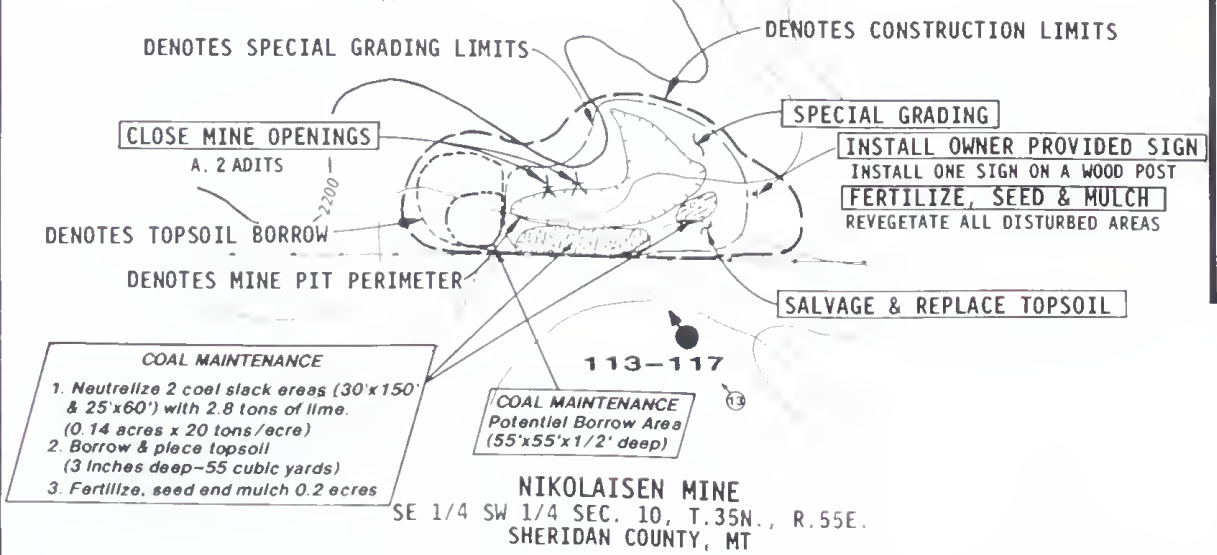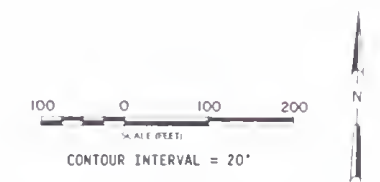

OLSEN - ESTIMATED QUANTITIES	
ITEM DESCRIPTION	UNITS
SALVAGE & REPLACE TOPSOIL	100 C.Y.
CLOSE MINE OPENINGS	
ADIT	1 EACH
WATER FLOODING & INJECTION	3.0 MGAL.
SUBSIDENCE BACKFILL	20 C.Y.
PROVIDE WATER	4.2 MGAL.
FERTILIZE, SEED & MULCH	0.7 ACRE
* BASED ON ASSUMED FIELD CONDITIONS: DRY WEIGHT - 113 P.C.F. IN-SITU MOISTURE CONTENT - 6% OPTIMUM MOISTURE CONTENT - 12% WORK ITEMS WATER APPLIED TO: CLOSE MINE OPENINGS AND SUBSIDENCE BACKFILL	

LANDOWNER

DARVIS RANCH, INC.
RICK DARVIS
408 E. LANCASTER
PLENTYWOOD, MT. 59254
PHONE (406) 765-2030

COAL MAINTENANCE
NIKOLAISEN MINE SITE
SECTION 10, T35N R55E
SHERIDAN COUNTY, MONTANA

Date: February 1993
Sheet No: 15 of 18

SPECTRUM ENGINEERING
Mining and Civil Engineers
Billings, Montana

NOTICE

ABANDONED COAL MINE(S) UNDERLIE THIS SITE. MANY POTENTIAL HAZARDS EXIST. THE EXTENT OF THESE HAZARDS IS NOT FULLY KNOWN. CONTRACTORS AND OTHER PERSONS WORKING AT THE SITE SHALL APPRISE THEMSELVES OF THE CONDITIONS AND TAKE WHATEVER STEPS ARE DEEMED NECESSARY TO INSURE SAFETY WHILE PERFORMING THEIR DUTIES.

ADDITIONAL INFORMATION PERTAINING TO THIS SITE MAY EXIST IN THE DEPARTMENT OF STATE LANDS' FILES OR AT THE OFFICES OF THEIR ENGINEERING REPRESENTATIVE AND SUCH MATERIAL IS AVAILABLE FOR REVIEW BY THOSE INTERESTED IN DOING SO.

STATE OF MONTANA
DEPT. OF STATE LANDS
RECLAMATION DIVISION

THESE TOPO MAPS WERE PREPARED FROM ENLARGEMENTS OF THE USGS MAPS. THEREFORE, THE SCALE IS APPROXIMATE AND SUITABLE ONLY FOR PLANNING PURPOSES.

L. C. Hanson Co.
CONSULTING, CIVIL, SANITARY, MUNICIPAL AND STRUCTURAL ENGINEERS
HELENA, MONTANA

NIKOLAISEN MINE
GENERAL LAYOUT & SITE PLAN

DRAWN BY
L.D.R.
L.B.P.

CHECKED BY
A.W.N.

APPROVED BY
Rick Darvis



REVISED
AS BUILT
2-22-91

AS SHOWN


SHEET NO.
6
7

PROJECT NO.



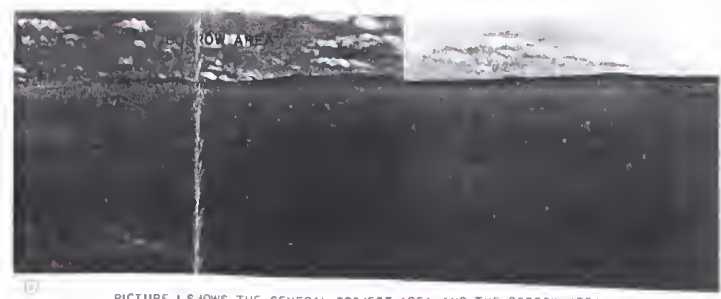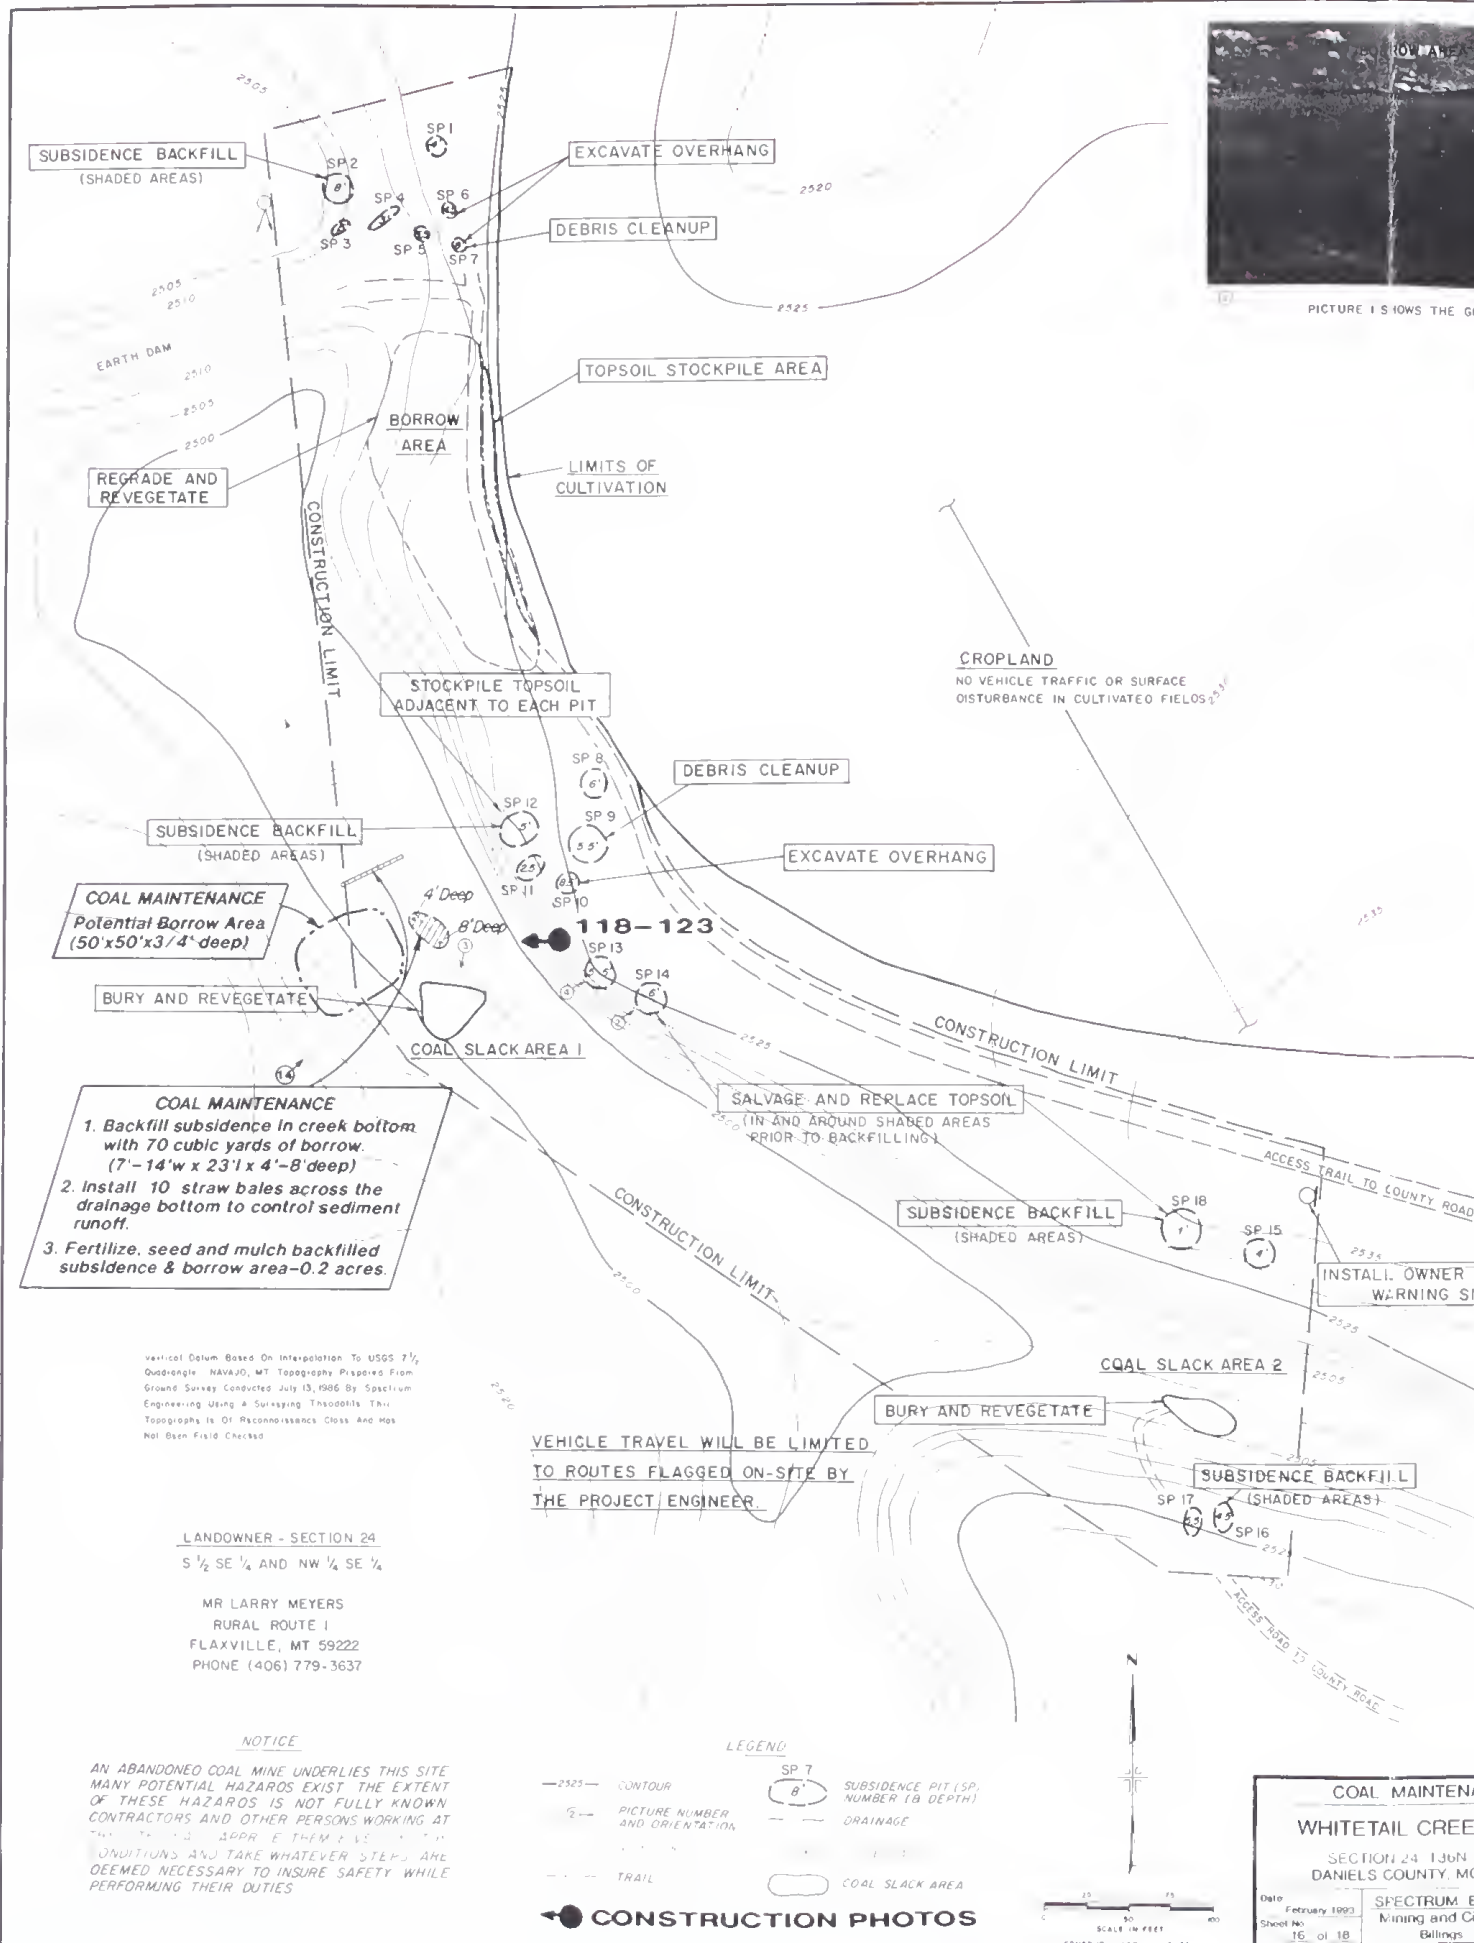

PICTURE 1 SHOWS THE GENERAL PROJECT AREA AND THE BORROW AREA

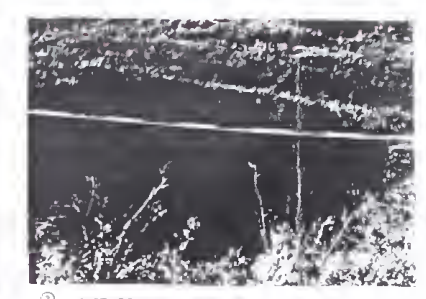


PICTURE 2 SHOWS SUBSIDENCE PIT 14




PICTURE 3 SHOWS COAL SLACK AREA 1



PICTURE 4 SHOWS SUBSIDENCE PIT 13

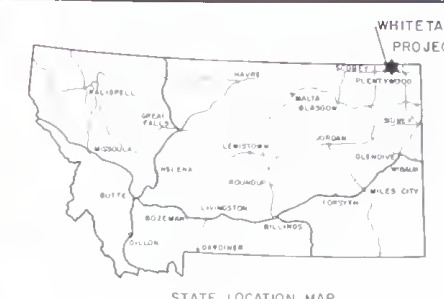


STATE LOCATION MAP

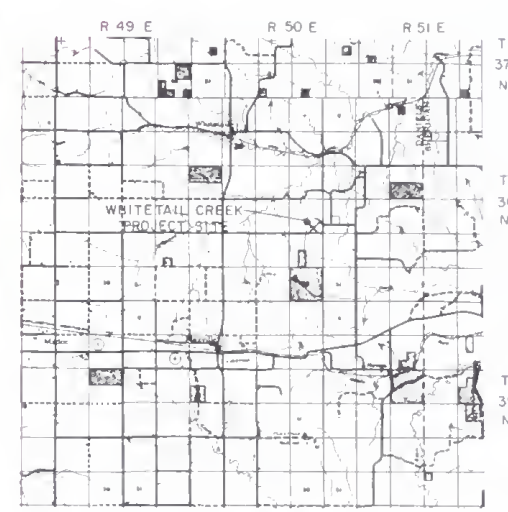


VICINITY ACCESS MAP

WORK DESCRIPTION
BACKFILL SUBSIDENCE PITS WITH MATERIAL FROM THE BORROW AREA (APPROXIMATELY 8 FT OF BORROW DEPTH) SUBSIDENCE PITS 6, 7, 8, 10, 11, 12, 13, 14, 15, 16, 17, 18 MUST BE EXCAVATED AND PLACED INTO THE PITS PRIOR TO PLACING THE BACKFILL MATERIAL. BURY THE COAL SLACK AREAS WITH SUITABLE SOIL MATERIAL. REGRADE BORROW AND BACKFILL AREAS TO PROVIDE UNIFORM SLOPES AND SMOOTH TRANSITION WITH EXISTING CONTOURS. ALL DEBRIS SHALL BE DISPOSED OF IN DESIGNATED AREA. ALL DISTURBANCE AREAS WILL BE SEED, FERTILIZED AND MULCHED. ADDITIONAL DETAILED WORK DESCRIPTIONS ARE LOCATED IN THE SPECIAL PROVISIONS.

DESCRIPTION OF RECLAMATION FEATURES			
ITEM	DIMENSIONS (FEET)	DEPTH (FEET)	ESTIMATED VOID VOLUME (CUBIC YARDS)
SP 1	13 x 13	4	44
SP 2	17 x 17	8	7
SP 3	6 x 12	5	9
SP 4	9 x 24	5	3
SP 4A	6 x 8	2.5	11
SP 5	10 x 12	5.5	9
SP 6	8 x 10	4.5	17
SP 7	8 x 8	6	30
SP 8	17 x 17	5.5	42
SP 9	22 x 22	8.5	25
SP 10	10 x 10	2.5	11
SP 11	13 x 18	5	46
SP 12	18 x 28	6	27
SP 13	17 x 17	4	14
SP 14	13 x 15	4.5	20
SP 15	12 x 18	5.5	23
SP 16	22 x 22	1	7
COAL SLACK AREA 1	29 x 35	0	-
COAL SLACK AREA 2	14 x 28	0	-
BORROW AREA	0.26 ACRES	-	-
REVEGETATION	0.4 ACRES	-	-

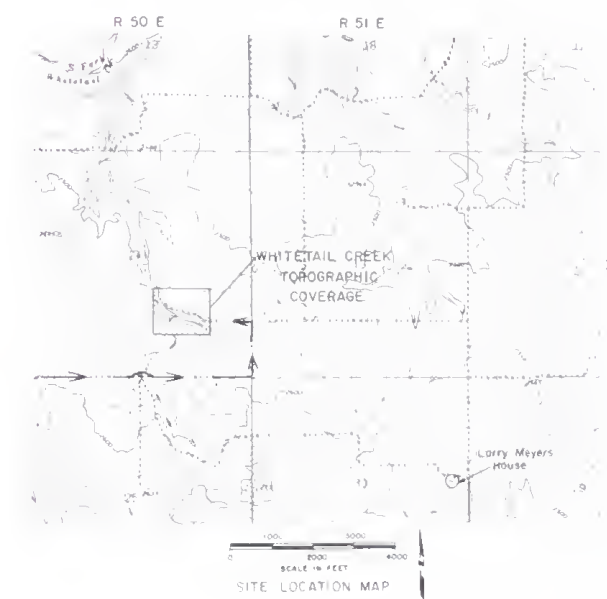


SITE LOCATION MAP

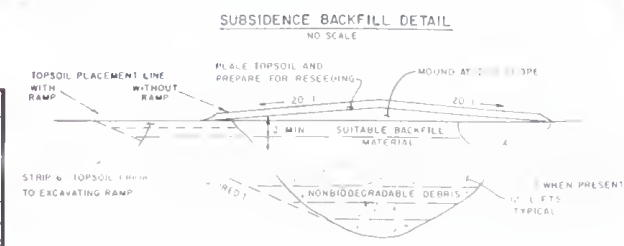

COAL MAINTENANCE
WHITETAIL CREEK SITE
SECTION 24, T36N, R50E
DANIELS COUNTY, MONTANA
Date: February 1993
Sheet No: 16 of 18
SPECTRUM ENGINEERING
Mining and Civil Engineers
Billings, Montana

SITE PLAN AND GENERAL LAYOUT
WHITETAIL CREEK SITE
SE 1/4 SECTION 24, T36N, R50E
DANIELS COUNTY, MONTANA
STATE OF MONTANA
DEPARTMENT OF STATE LANDS
ABANDONED MINE RECLAMATION BUREAU, RECLAMATION DIVISION
DATE: 12-19-86
APPROVED BY: [Signature]
REVISIONS: [Table]
SHEET NO: 16 of 18

AS-BUILT DRAWING AND PHOTO INDEX

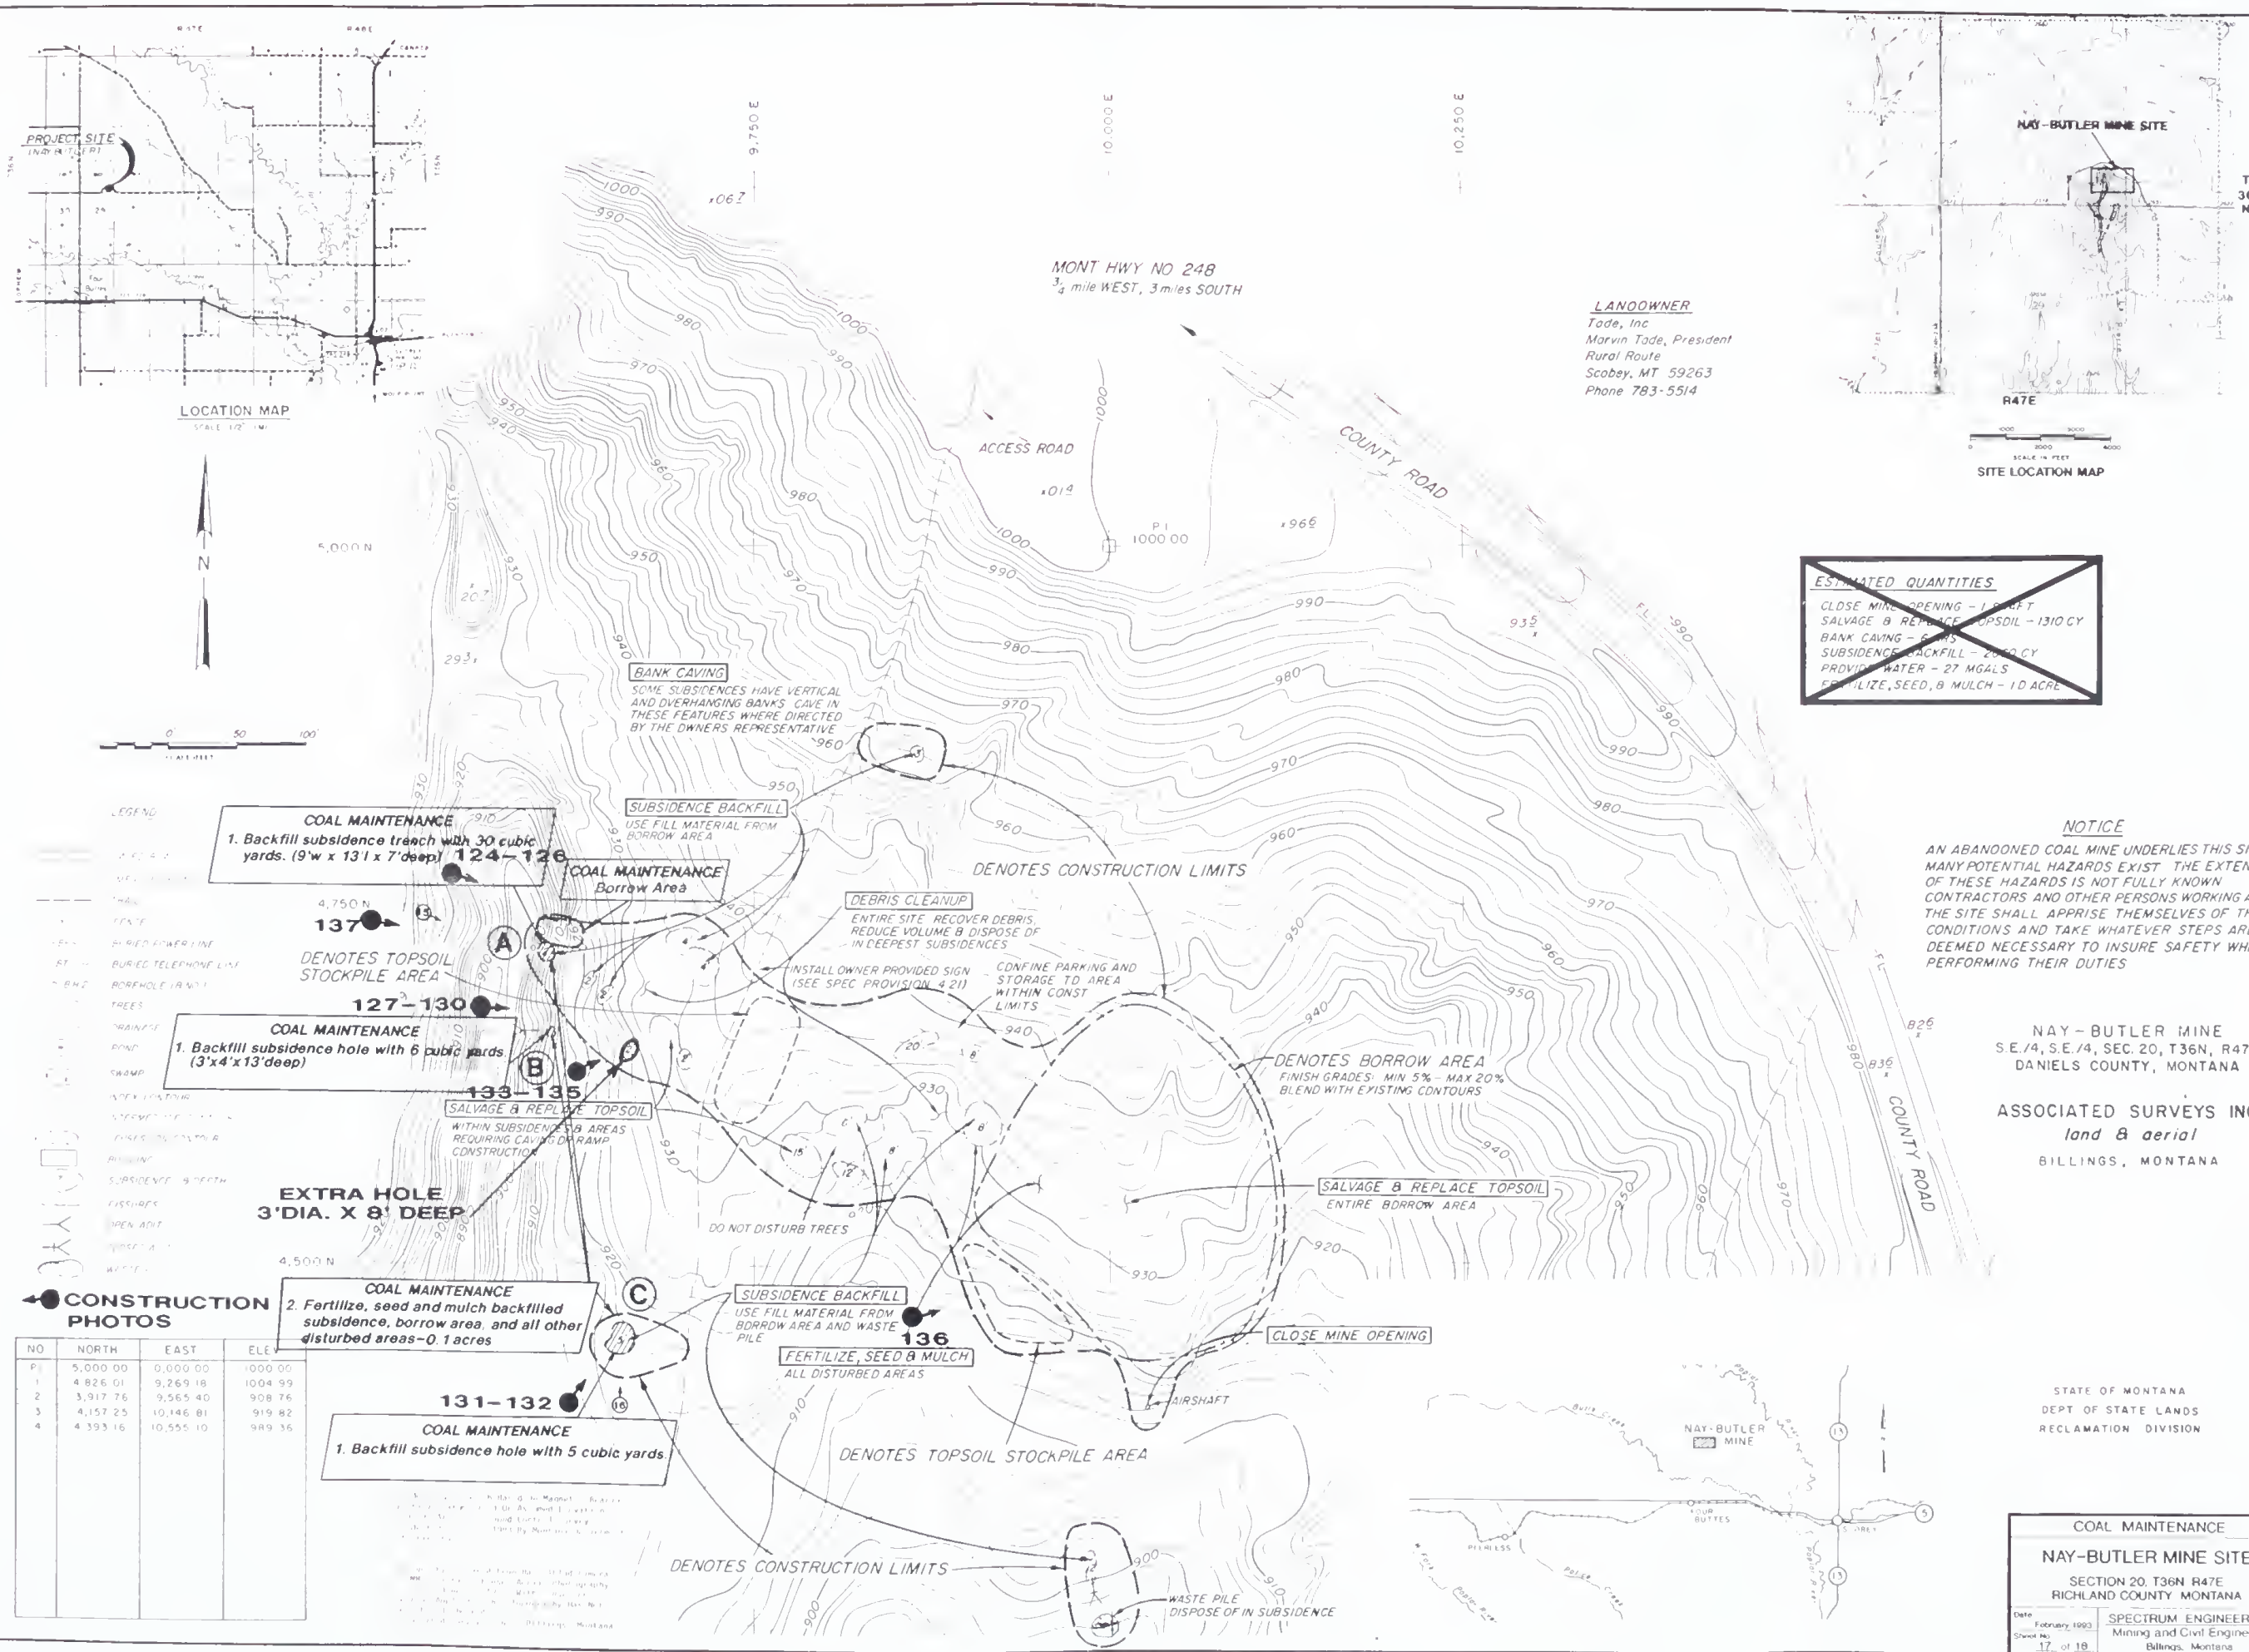



1. The first part of the document is a list of the names of the persons who were present at the meeting.

2. The second part of the document is a list of the names of the persons who were absent from the meeting.

3. The third part of the document is a list of the names of the persons who were present at the meeting.

4. The fourth part of the document is a list of the names of the persons who were present at the meeting.

5. The fifth part of the document is a list of the names of the persons who were present at the meeting.

6. The sixth part of the document is a list of the names of the persons who were present at the meeting.

**1993 NORTHEASTERN MT COAL MAINTENANCE PROJECT
PHOTO DESCRIPTIONS**

<u>ASSIGNED NUMBER</u>	<u>DATE TAKEN</u>	<u>SUBJECT OR COMMENTS</u>
EQUIPMENT		
1	09-10-93	Cat 416B backhoe with loader.
2	09-10-93	Ford 370 dump truck with water tank.
3	09-10-93	Bame 3-axle trailer.
4	09-10-93	GMC pickup with fuel tank.
5	09-10-93	Brillion grass seeder.
6	09-10-93	JD 770 tractor with loader.
7	09-10-93	Six foot spring tooth.
8	09-10-93	Seven foot crimper.
9	09-10-93	Smith 2-axle trailer.
BLACK DIAMOND NORTH SITE		
10	01-25-93	Pre-construction of Subsidence Hole A.
11	09-10-93	Subsidence Hole A excavated.
12	09-10-93	Hole A backfilled and topsoiled.
13	09-11-93	Hole A finished.
14	09-09-93	Pre-construction of Subsidence Hole B.
15	09-09-93	Pre-construction of Subsidence Hole B.
16	09-10-93	Subsidence Hole B excavated.
17	09-10-93	Filling Hole B with backhoe.
18	09-10-93	Hole B backfilled and topsoiled.
19	09-11-93	Hole B and borrow finished.
20	09-10-93	Borrow area.
21	09-10-93	Spring tooth on borrow area.
22	09-10-93	Borrow area topsoiled.

**1993 NORTHEASTERN MT COAL MAINTENANCE PROJECT
PHOTO DESCRIPTIONS**

<u>ASSIGNED NUMBER</u>	<u>DATE TAKEN</u>	<u>SUBJECT OR COMMENTS</u>
NORTH WIBAUX MINE		
23	01-25-93	Pre-construction of subsidence holes.
24	09-11-93	Hole A excavated from bottom.
25	09-11-93	Hole A filled.
26	09-11-93	Crimping of Hole A.
27	09-11-93	Finished site.
28	09-11-93	Pre-construction of Hole B.
29	09-11-93	Hole B excavated.
30	09-11-93	Compaction of Hole B.
31	09-11-93	Borrow area.
32	09-12-93	Coal slack pile and borrow area.
33	09-11-93	Holes A and B complete.
MULLENDORE SITE		
34	04-21-93	Pre-construction of Subsidence Holes 1-13.
35	04-21-93	Pre-construction of Subsidence Holes 1-13.
36	04-21-93	Pre-construction of Subsidence Holes 1-13.
37	04-21-93	Pre-construction of Subsidence Holes 1-13.
38	09-12-93	West side filled and mulched.
39	09-12-93	East side filled and mulched.
40	09-12-93	Borrow area seeded, fertilized, and mulched.

**1993 NORTHEASTERN MT COAL MAINTENANCE PROJECT
PHOTO DESCRIPTIONS**

<u>ASSIGNED NUMBER</u>	<u>DATE TAKEN</u>	<u>SUBJECT OR COMMENTS</u>
JOHNSON HILL SITE		
41	09-12-93	Pre-construction of one of the erosional channels.
42	09-13-93	Repairing erosional channels.
43	09-16-93	Crimped hay on erosion channel.
44	09-16-93	Erosional channels complete.
45	01-25-93	Aerial view of coal slack area.
46	09-13-93	Load of bag lime.
47	09-14-93	Sack of lime.
48	09-13-93	Spreading lime on Coal Slack Area #1.
49	09-14-93	Working in lime on #2 Coal Pile.
50	09-15-93	Topsoil at Coal Pile #2.
51	09-13-93	Topsoil being laid on Coal Slack Pile #1.
52	09-16-93	Fertilizing Coal Slack Pile #1.
53	09-16-93	Coal Slack Pile #2 ready for seeding, fertilizing, and mulching.
54	09-16-93	Seeding Coal Pile #1.
55	09-16-93	Close-up of drill seeded rows.
56	09-16-93	Coal Slack Pile #2 completed.
57	09-15-93	Loading topsoil at borrow area.
58	09-16-93	Borrow area ready for seeding, fertilizing, and mulching.
59	09-16-93	Borrow area after reclamation completed.
SCHMIDT SITE		
60	01-25-93	Pre-construction view of air shaft subsidence.
61	09-17-93	Air shaft filled in.
62	09-17-93	Site revegetated.

**1993 NORTHEASTERN MT COAL MAINTENANCE PROJECT
PHOTO DESCRIPTIONS**

<u>ASSIGNED NUMBER</u>	<u>DATE TAKEN</u>	<u>SUBJECT OR COMMENTS</u>
AHREN SITE		
63	09-17-93	Pre-construction of Subsidence Holes A & B.
64	09-17-93	Pre-construction of Subsidence Holes A & B.
65	09-17-93	Subsidence Holes A & B filled in.
66	09-17-93	Subsidence Hole A & B being crimped.
67	09-17-93	Subsidence Hole A & B being crimped.
68	09-17-93	Pre-construction of Subsidence Holes A & B.
69	09-17-93	Subsidence Hole C filled in.
70	09-17-93	Subsidence Hole C being crimped.

SEVEN SISTERS SITE

71	09-17-93	Pre-construction of opening.
72	09-18-93	Excavation of collapsed roof.
73	09-18-93	Excavation of collapsed roof.
74	09-18-93	Collapsed opening backfilled with borrow.
75	09-18-93	Collapsed opening backfilled with borrow.
76	09-20-93	Drill seeding coal slack area.
77	09-20-93	Borrow area and collapse area with mulch.
78	09-18-93	152½ yds out of borrow area.
79	09-20-93	Borrow area with mulch.
80	09-20-93	Crimping borrow area.

CANYON CREEK SITE

81	09-18-93	Pre-construction of site.
82	01-25-93	Pre-construction of site.

**1993 NORTHEASTERN MT COAL MAINTENANCE PROJECT
PHOTO DESCRIPTIONS**

<u>ASSIGNED NUMBER</u>	<u>DATE TAKEN</u>	<u>SUBJECT OR COMMENTS</u>
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83	09-18-93	Pre-construction of site.
84	09-20-93	Excavation of subsidence.
85	09-20-93	Excavation of subsidence.
86	09-21-93	Compaction of subsidence.
87	09-21-93	Subsidence filled.
88	09-21-93	Seeding subsidence area.
89	09-21-93	Subsidence area completed.
90	09-21-93	Borrow area.
91	09-21-93	Borrow area completed.

BEMER SITE

92	09-19-93	Pre-construction of adit opening.
93	09-19-93	Pre-construction of adit opening.
94	09-21-93	Excavation of adit.
95	09-21-93	Excavation of adit.
96	09-22-93	Adit backfilled and revegetated.
97	09-22-93	Adit backfilled and revegetated.

ANTELOPE II SITE

98	09-22-93	Pre-construction of erosional channels.
99	09-22-93	Erosion channels filled in.
100	09-23-93	Excavation of diversion ditch.
101	09-23-93	Revegetation complete at site.

**1993 NORTHEASTERN MT COAL MAINTENANCE PROJECT
PHOTO DESCRIPTIONS**

<u>ASSIGNED NUMBER</u>	<u>DATE TAKEN</u>	<u>SUBJECT OR COMMENTS</u>
MEYER SITE		
102	01-25-93	Aerial view of subsidence hole.
103	01-25-93	Pre-construction of subsidence hole.
104	09-23-93	Subsidence backfilled and revegetated.
NEW RAYMOND SITE (NICKLOCKIN)		
105	09-22-93	Pre-construction of subsidence hole (4' x 4' x 2' deep).
106	09-22-93	Post-construction view (no reveg in plowed field per landowner).
RAYMOND SITE		
107	09-25-93	Pre-construction of extra air shaft.
108	09-25-93	Excavation of extra air shaft.
109	09-25-93	Excavated air shaft prior to backfilling.
110	09-25-93	Excavation of assumed air shaft (per landowner).
111	04-21-93	Pre-construction of scattered boulders.
112	09-25-93	Piled 95 cy of boulders off of hay field.
NIKOLAISEN SITE		
113	01-26-93	Pre-construction view of coal slack piles.
114	09-23-93	Pre-construction of coal slack piles.
115	09-23-93	Pre-construction of coal slack piles.
116	09-24-93	Coal slack pile revegetated.
117	09-24-93	Borrow area revegetated.

1993 NORTHEASTERN MT COAL MAINTENANCE PROJECT PHOTO DESCRIPTIONS

<u>ASSIGNED NUMBER</u>	<u>DATE TAKEN</u>	<u>SUBJECT OR COMMENTS</u>
WHITETAIL CREEK SITE		
118	01-25-93	Preconstruction aerial view of subsidence hole.
119	09-24-93	Pre-construction of subsidence hole.
120	09-26-93	Laying down straw bales.
121	09-26-93	Filling subsidence from borrow area.
122	09-26-93	Subsidence and borrow area ready for revegetation.
123	09-26-93	Crimping reclaimed area.
NAY-BUTLER SITE		
124	09-24-93	Pre-construction of Subsidence Hole A.
125	09-26-93	Borrow area and Trench A backfilled.
126	09-26-93	Borrow area and Trench A revegetated.
127	09-24-93	Pre-construction of Subsidence Hole B.
128	09-26-93	Subsidence Hole B backfilled.
129	09-26-93	Hole B revegetated.
130	09-26-93	Hole B revegetated.
131	09-26-93	Pre-construction of Subsidence Hole C.
132	09-26-93	Subsidence Hole C backfilled.
133	09-26-93	Pre-construction of extra subsidence hole.
134	09-26-93	Excavation of extra subsidence hole.
135	09-26-93	Excavation of extra subsidence hole.
136	09-26-93	View of #2 borrow area.
137	09-26-93	Entire area revegetation complete.

EQUIPMENT



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1993 NORTHEASTERN MONTANA COAL MAINTENANCE PROJECT

**BLACK DIAMOND
NORTH MINE SITE
T13N, R60E, SEC. 10
WIBAUX COUNTY**



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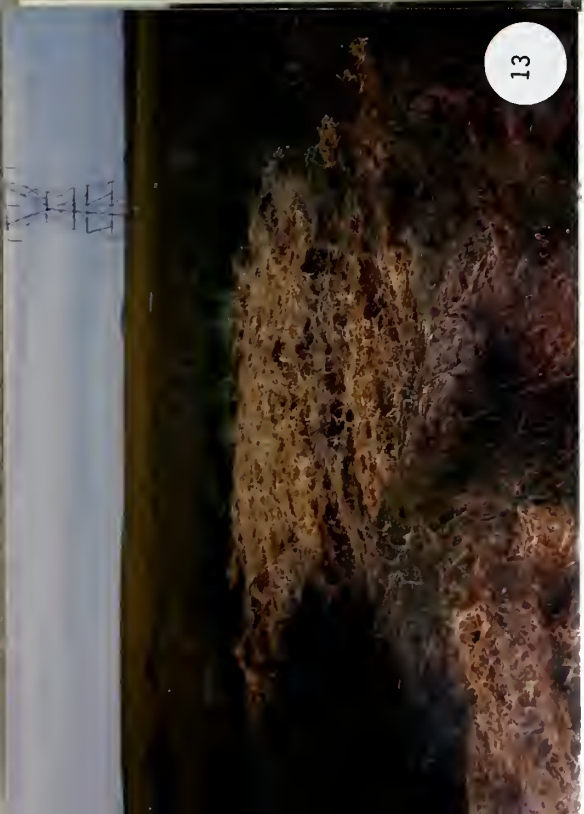
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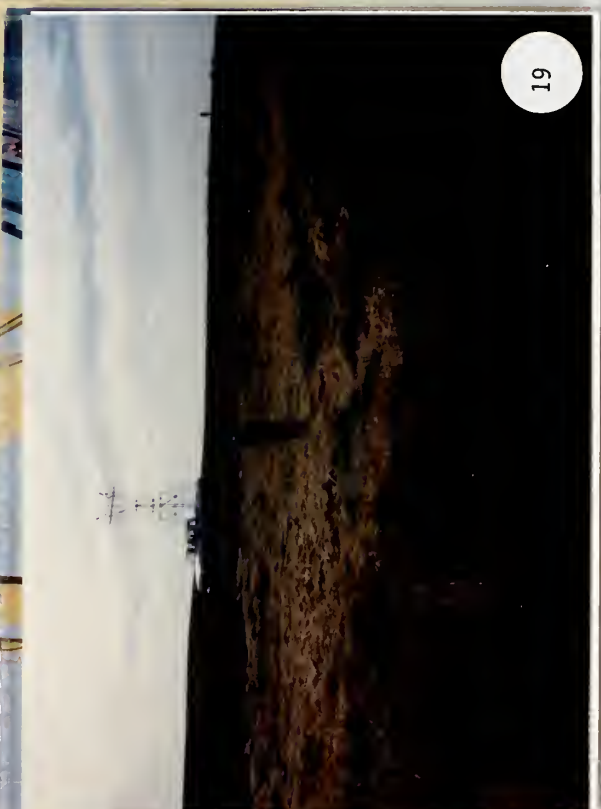
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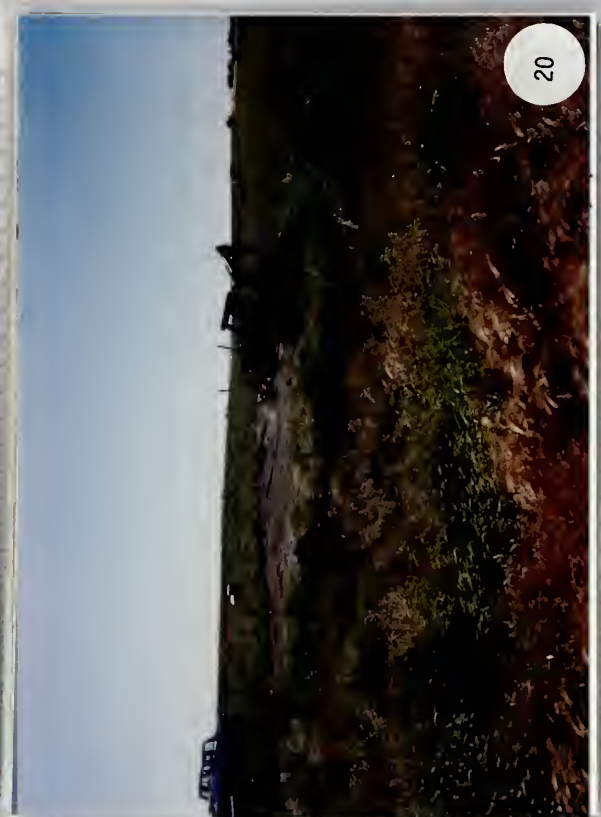
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NORTH WIBAUX SITE
T15N, R59E, SEC. 13
SE¹/₄NE¹/₄
WIBAUX COUNTY

HELICOPTER TRIP
JANUARY 25/26, 1993
JOEL CHAVEZ/
BILL MAEHL

22



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**NORTH WIBAUX
T15N, R59, SEC. 13
WIBAUX COUNTY**



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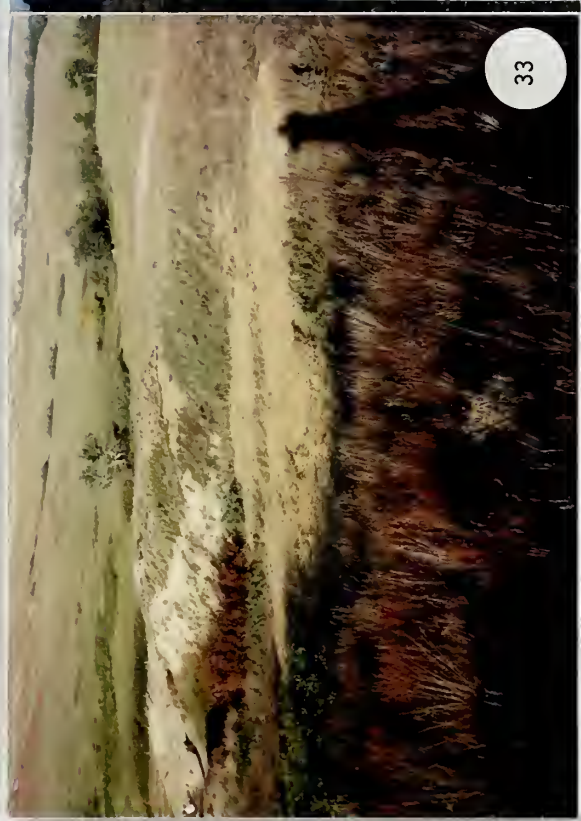
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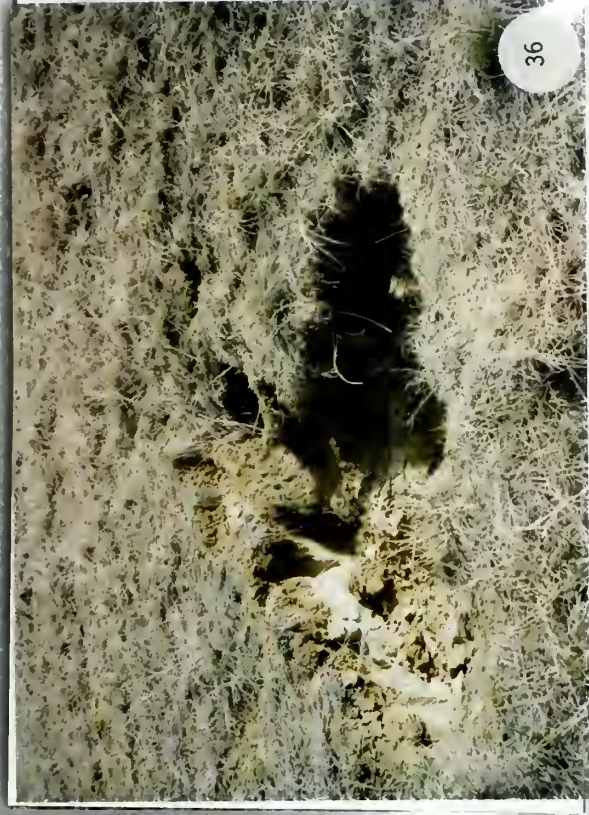


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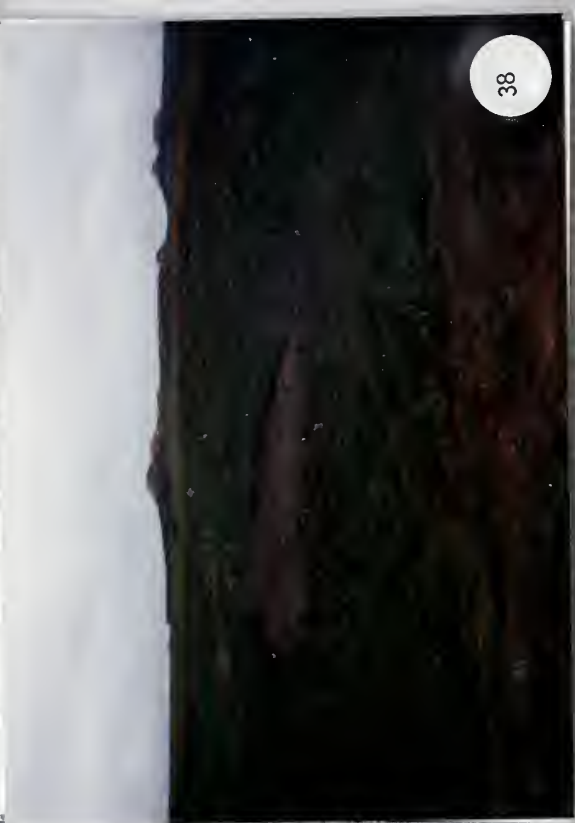
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**MULLENDORE SITE
T16N, R57E, SEC. 30
DAWSON COUNTY**





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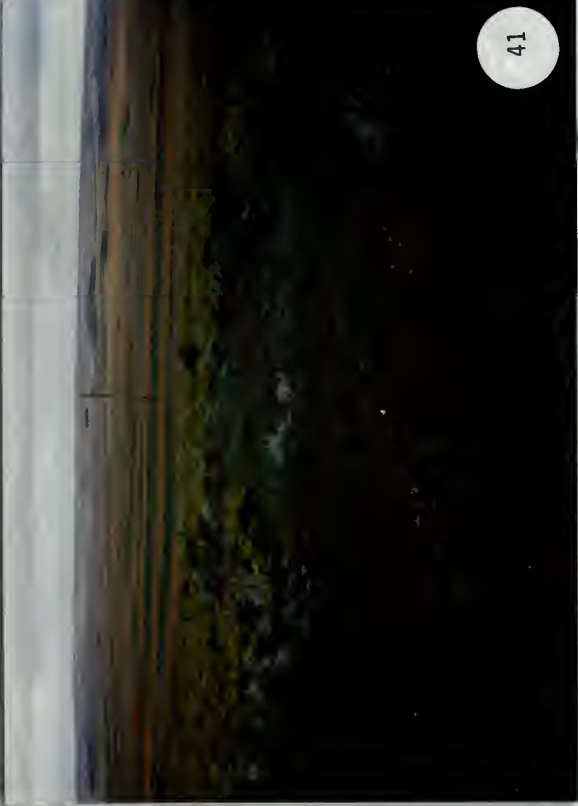
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**JOHNSON HILL SITE
T20N, R54E, SEC. 31
DAWSON COUNTY**

Johnson Hill Site




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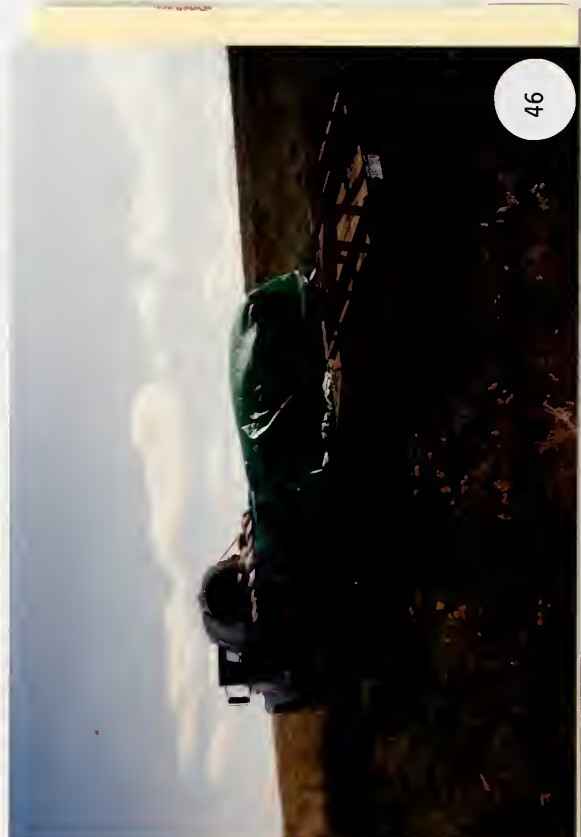
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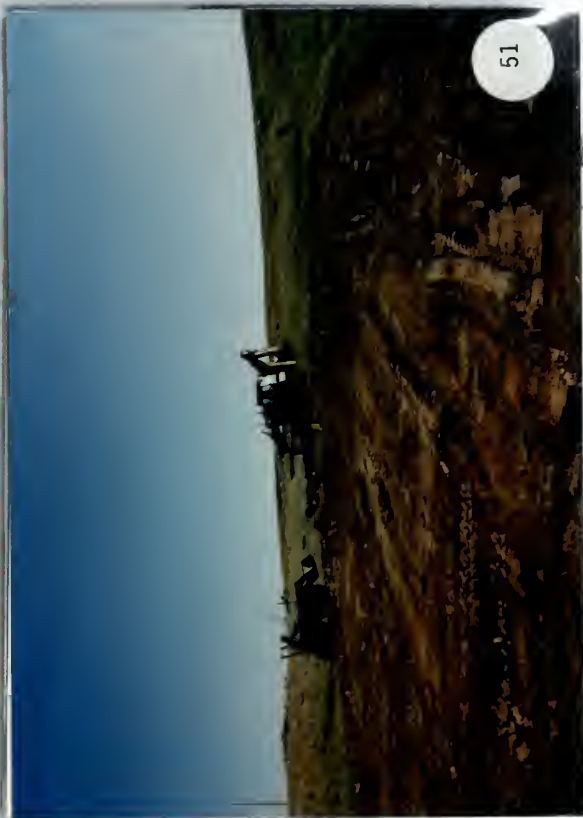


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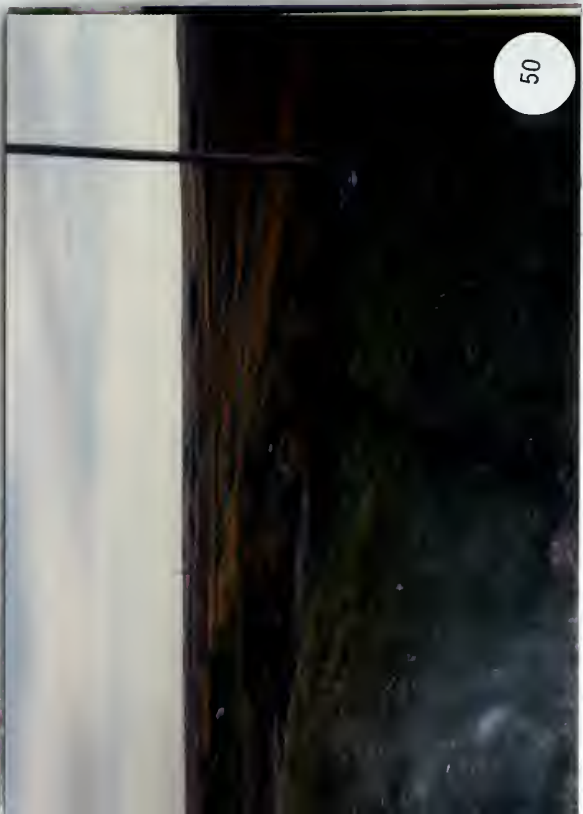
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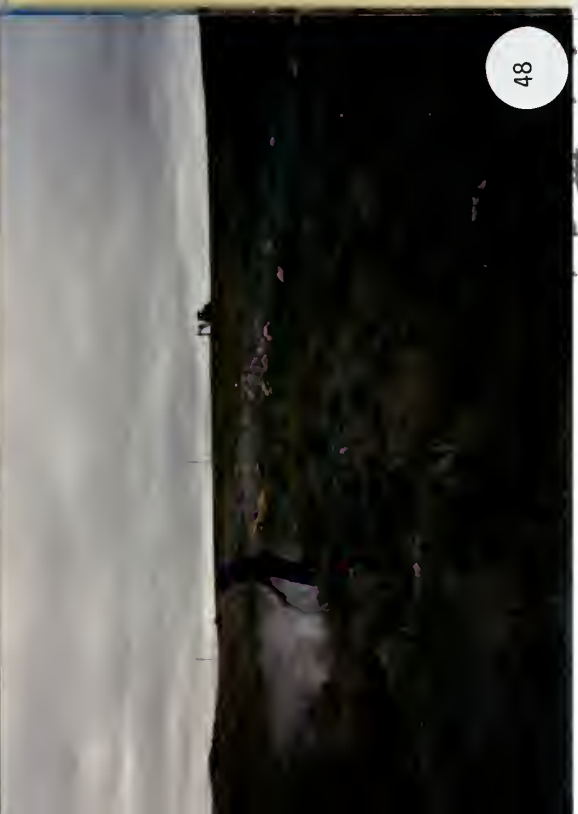
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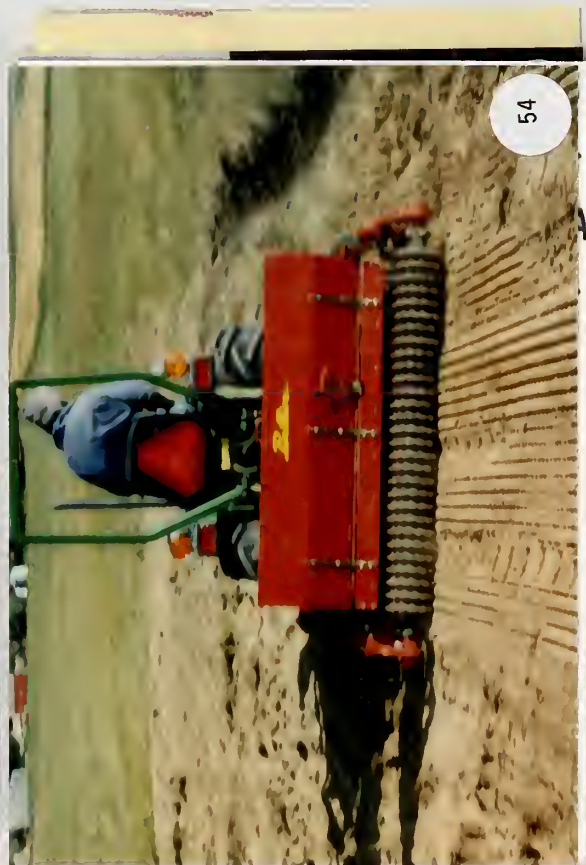


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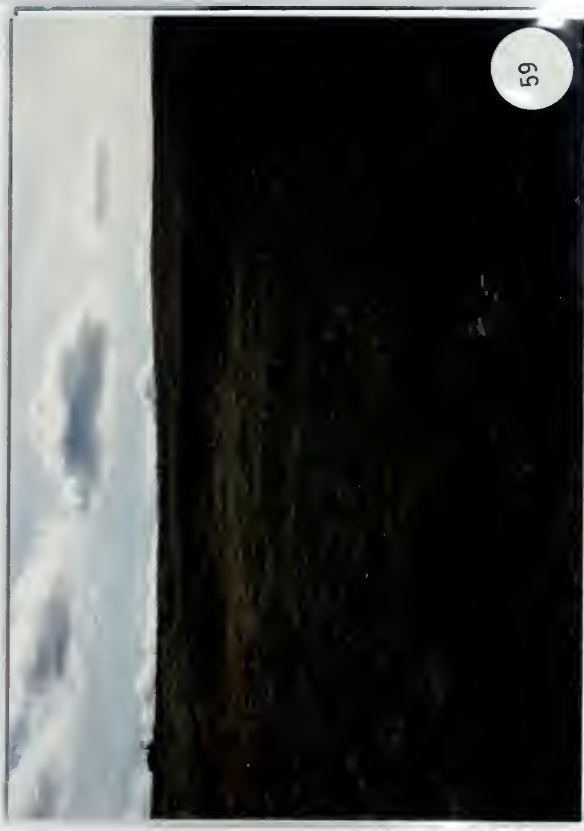
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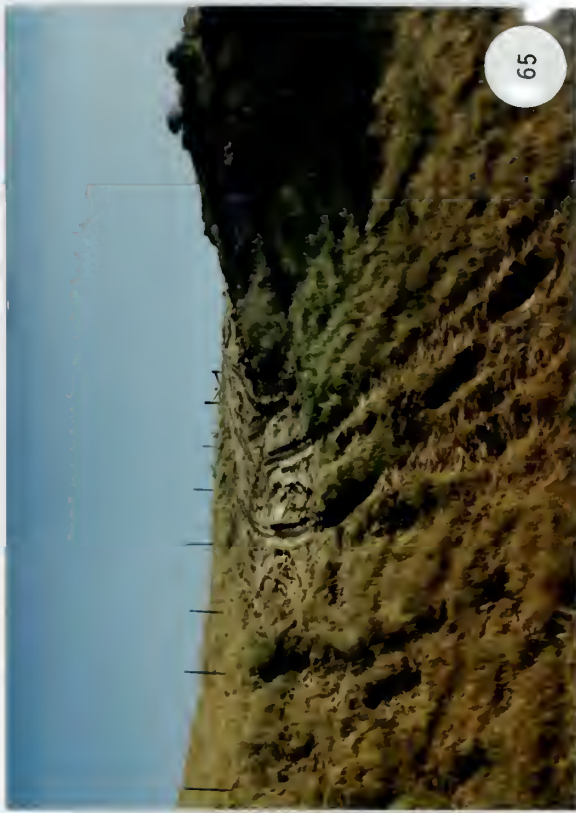


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**SCHMIDT SITE
T21N, R54E, SEC. 34
DAWSON COUNTY**

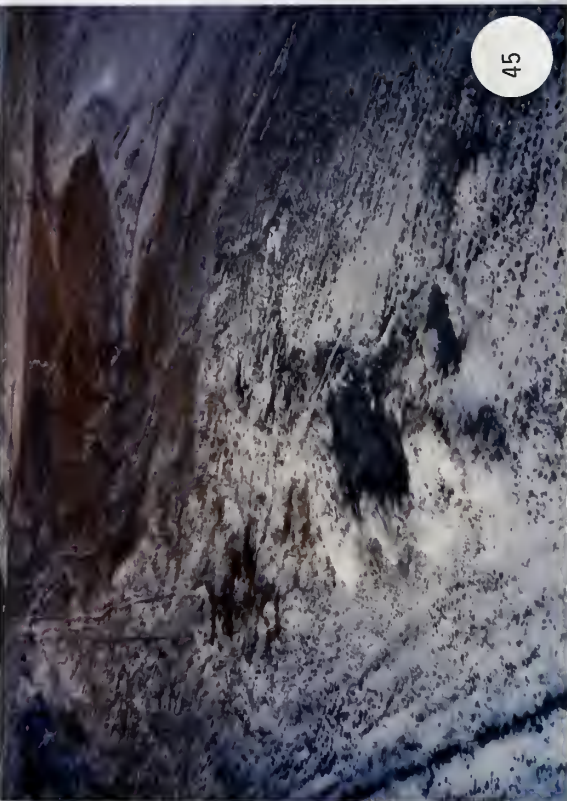


**AHREN MINE SITE
T23N, R53E, SEC. 26 & 27
RICHLAND COUNTY**






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Roll IV - C

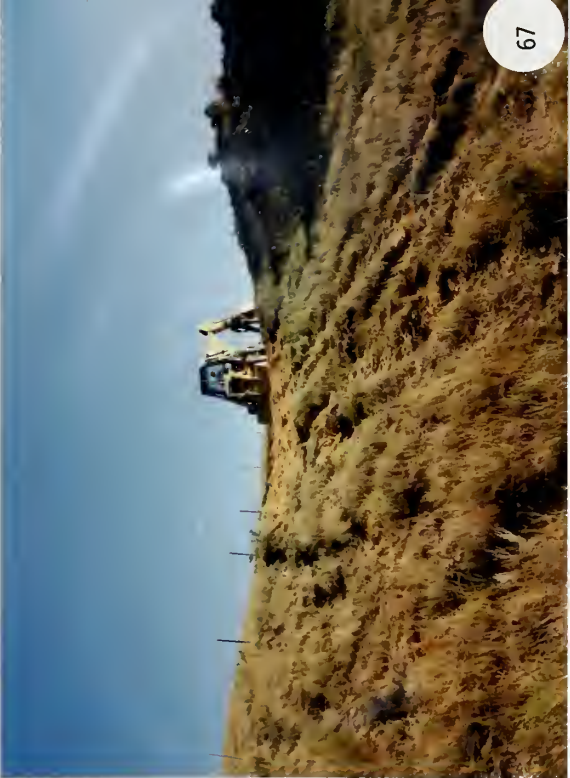1993 NORTHEASTERN MT COAL
MAINTENANCE PROJECT
DSL-AMRB 93-M03

Before, during and after construction photographs.
Photo descriptions are found in the final report.
Construction period: 9/9/93-9/26/93

Roll IV - B 14

1993 NORTHEASTERN MT COAL
MAINTENANCE PROJECT
DSL-AMRB 93-M03

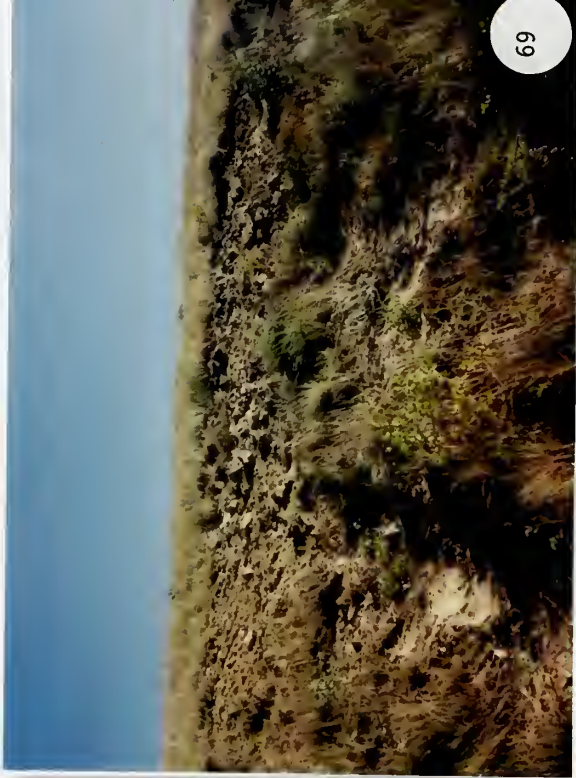
Before, during and after construction photographs.
Photo descriptions are found in the final report.
Construction period: 9/9/93-9/26/93

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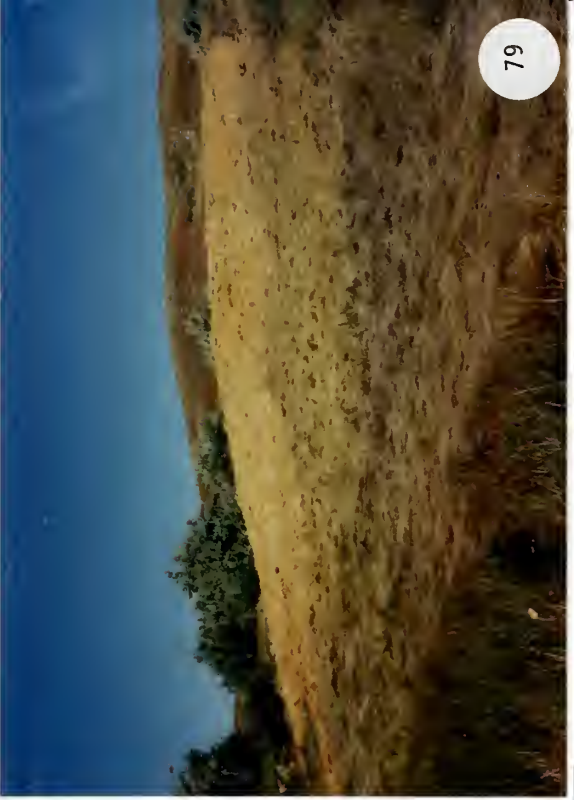
**SEVEN SISTERS MINE
T21N, R58E, SEC. 21
RICHLAND COUNTY**





1993 NORTHEASTERN MT COAL
MAINTENANCE PROUECT
DSL-AMRB 93-M03

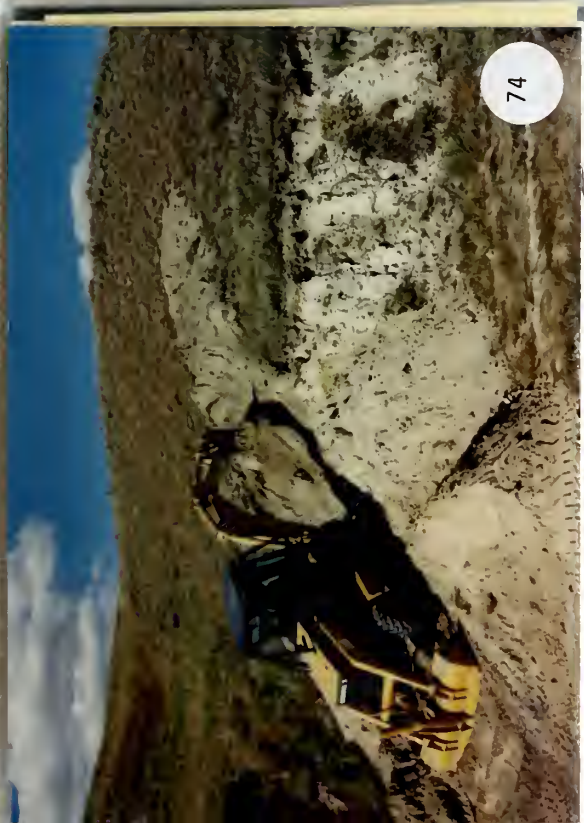Before, during and after construction photographs.
Photo descriptions are found in the final report.
Construction period: 9/9/93-9/26/93



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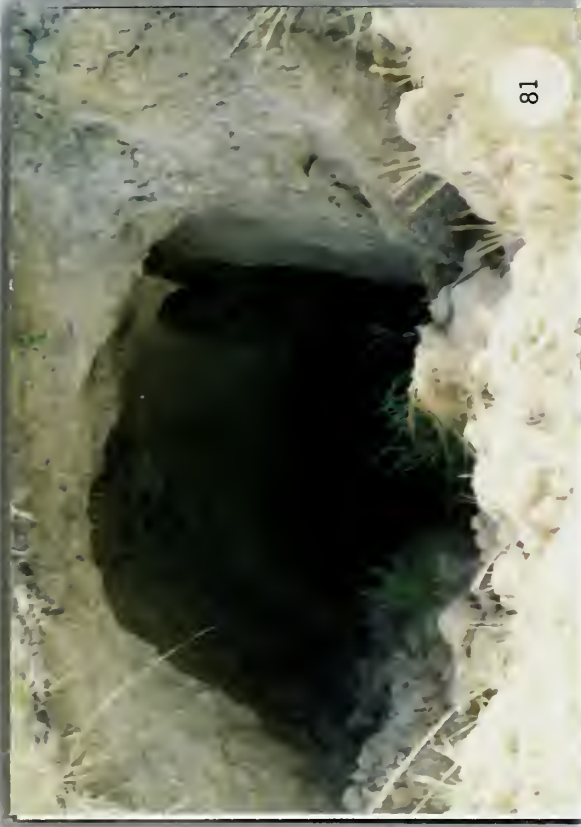


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**CANYON CREEK MINE
T21N, R59E, SEC. 17
RICHLAND COUNTY**



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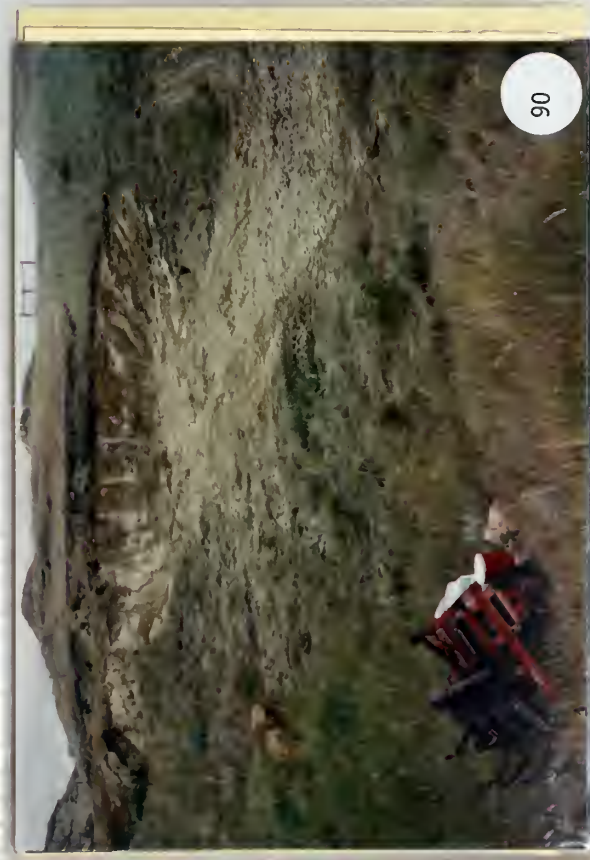
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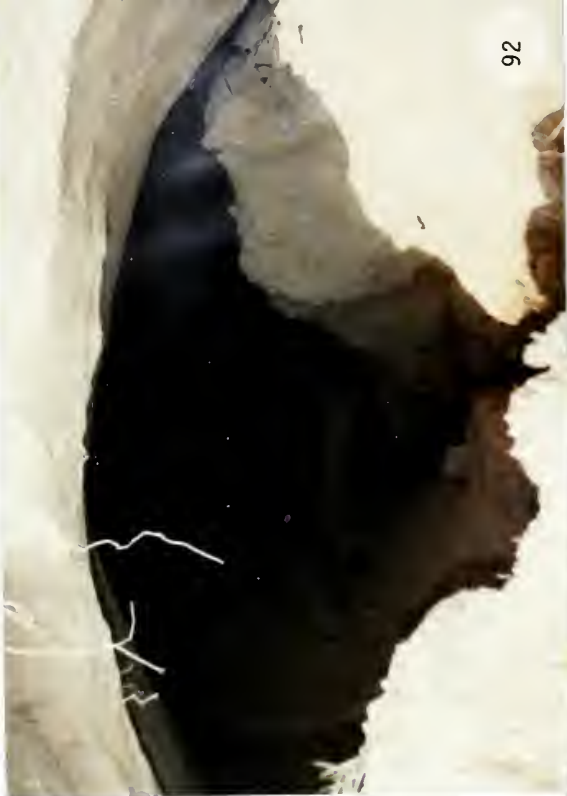


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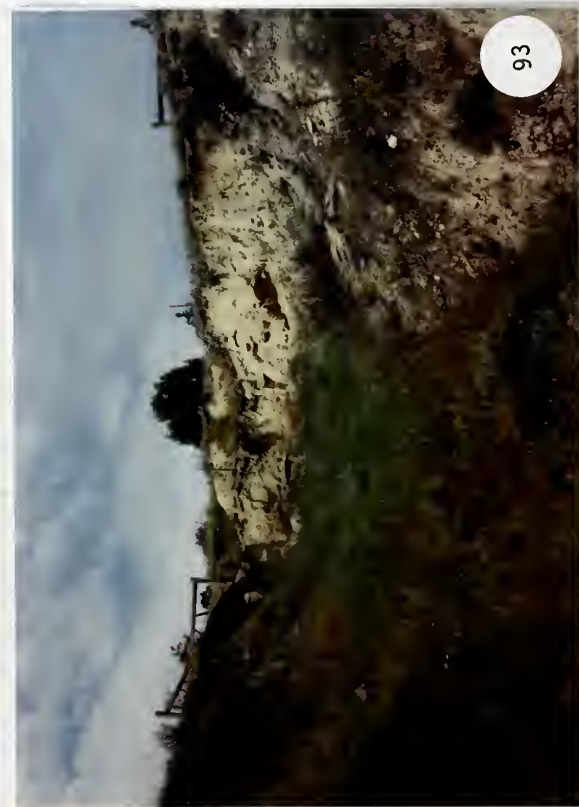


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**BEMER MINE SITE
T27N, R56E, SEC. 18
RICHLAND COUNTY**



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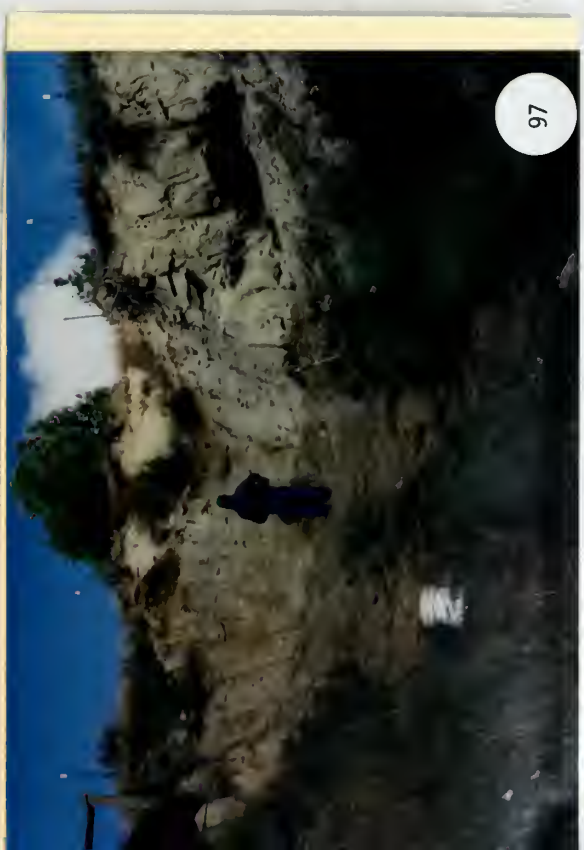
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1993 NORTHEASTERN MT COAL
MAINTENANCE PROJECT
DSL-AMRB 93-M03


Before, during and after construction photographs.
Photo descriptions are found in the final report.
Construction period: 9/9/93-9/26/93



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**ANTELOPE II MINE
T34N, R55E, SEC. 16
SHERIDAN COUNTY**



MEYER MINE SITE
T35N, R58E, SEC. 5
NE 1/4
SHERIDAN COUNTY

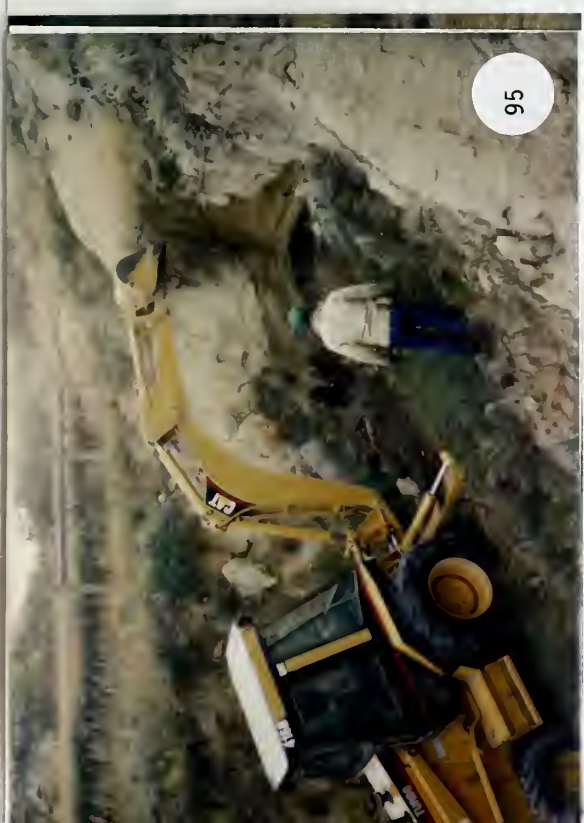
HELICOPTER TRIP
JANUARY 25/26, 1993
JOEL CHAVEZ/
BILL MAEHL

Roll IV # 14

1993 NORTHEASTERN MT COAL
MAINTENANCE PROJECT
DSL-AMRB 93-M03

Before, during and after construction photographs.
Photo descriptions are found in the final report.
Construction period: 9/9/93-9/26/93


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**MEYER MINE SITE
T35N, R58E, SEC. 5
SHERIDAN COUNTY**

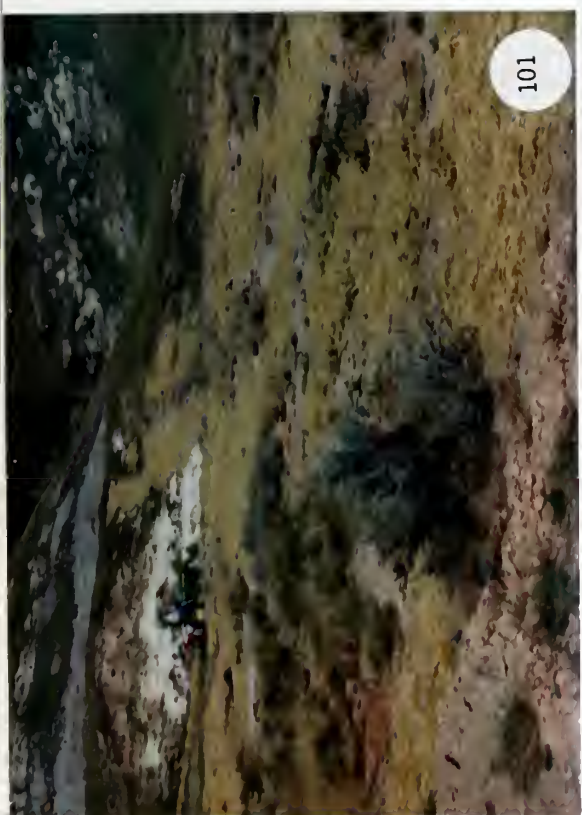

103



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**NEW RAYMOND SITE
(NICKLOCKIN)
T37N, R54E, SEC. 34
SHERIDAN COUNTY**

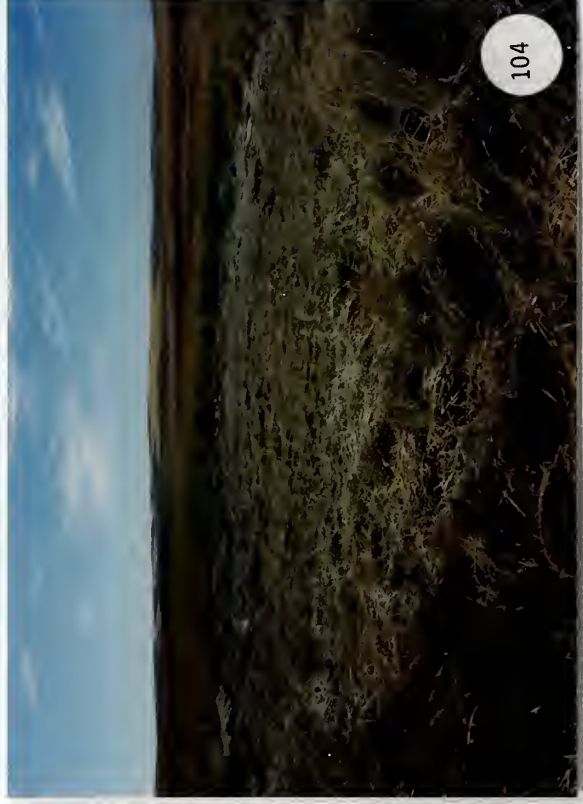48 77 1102




**RAYMOND MINE SITE
T36N, R55E, SEC. 6
SHERIDAN COUNTY**







**NIKOLAISEN MINE SITE
T35N, R55E, SEC. 10
SHERIDAN COUNTY**

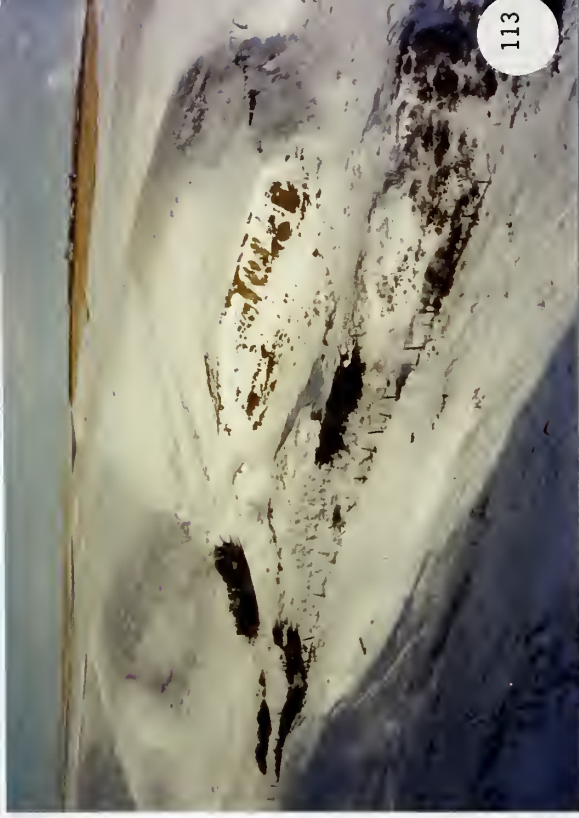

113

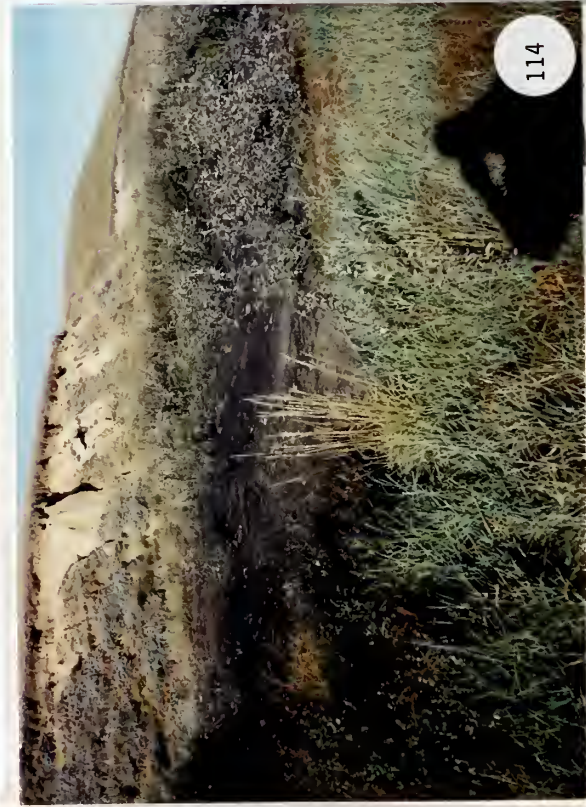

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WHITETAIL CREEK SITE
T36N, R50E, SEC. 24
SE $\frac{1}{4}$
DANIELS COUNTY

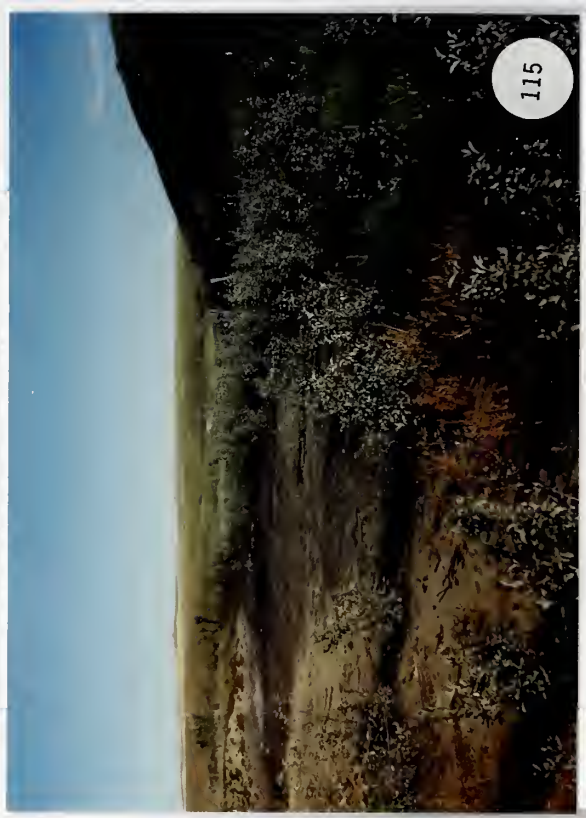HELICOPTER TRIP
JANUARY 25/26, 1993
JOEL CHAVEZ/
BILL MAEHL


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**WHITETAIL CREEK SITE
T36N, R50E, SEC. 24
DANIELS COUNTY**



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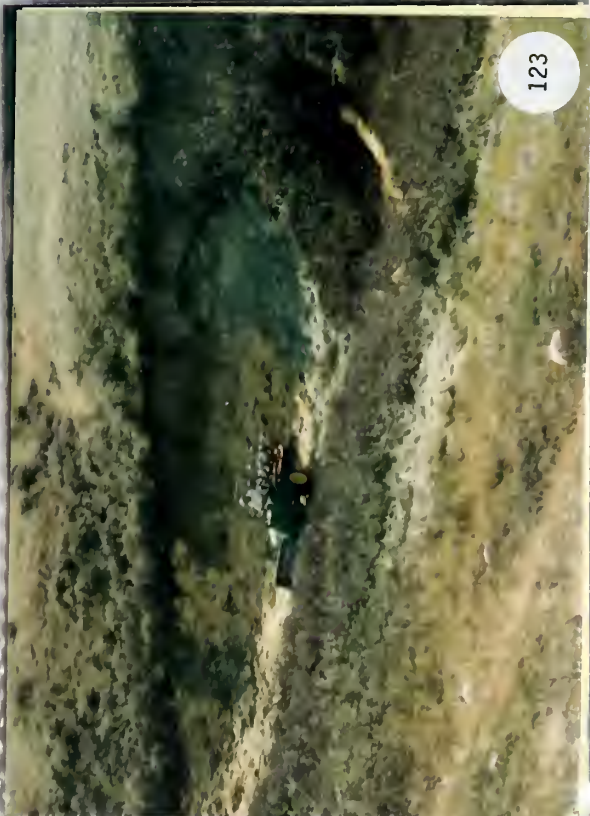


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1993 NORTHEASTERN MT COAL
MAINTENANCE PROJECT
DSL-AMRB 93-M03

Before, during and after construction photographs.
Photo descriptions are found in the final report.
Construction period: 9/9/93-9/26/93
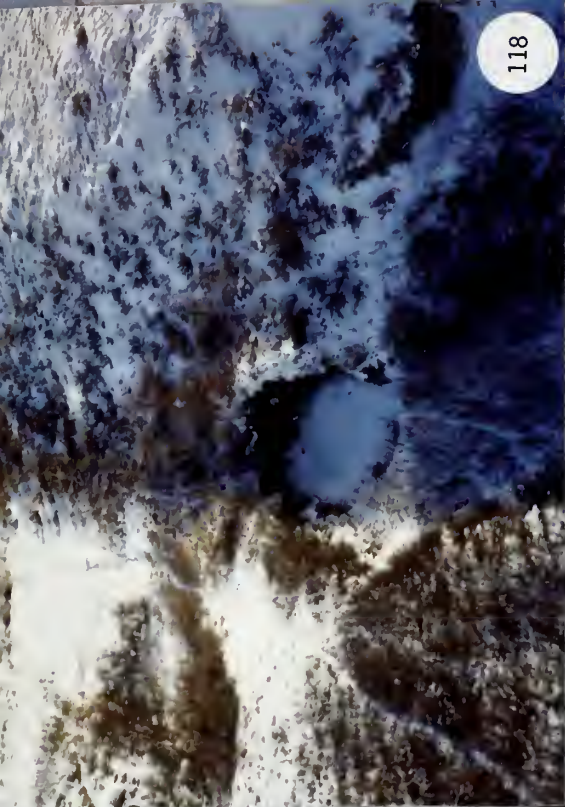
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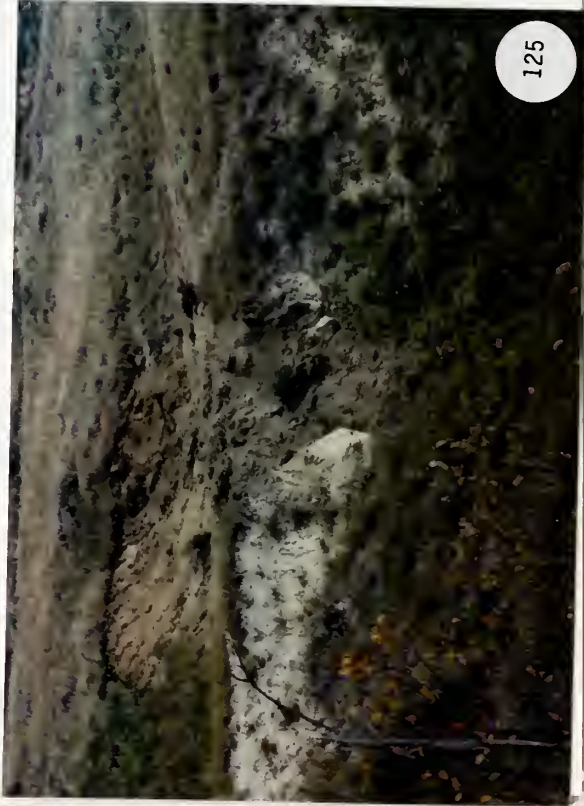
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**NAY-BUTLER MINE SITE
T36N, R47E, SEC. 20
DANIELS COUNTY**





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**1993 NORTHEASTERN MT COAL
MAINTENANCE PROJECT
DSL-AMRB 93-M03**

Before, during and after construction photographs.
Photo descriptions are found in the final report.
Construction period: 9/9/93-9/26/93

**1993 NORTHEASTERN MT COAL
MAINTENANCE PROJECT
DSL-AMRB 93-M03**

Before, during and after construction photographs.
Photo descriptions are found in the final report.
Construction period: 9/9/93-9/26/93

**1993 NORTHEASTERN MT COAL
MAINTENANCE PROJECT
DSL-AMRB 93-M03**

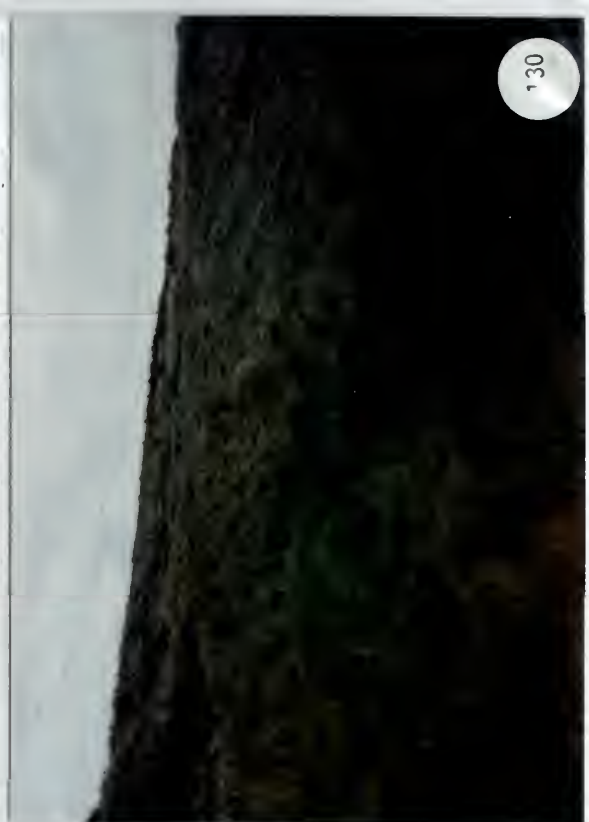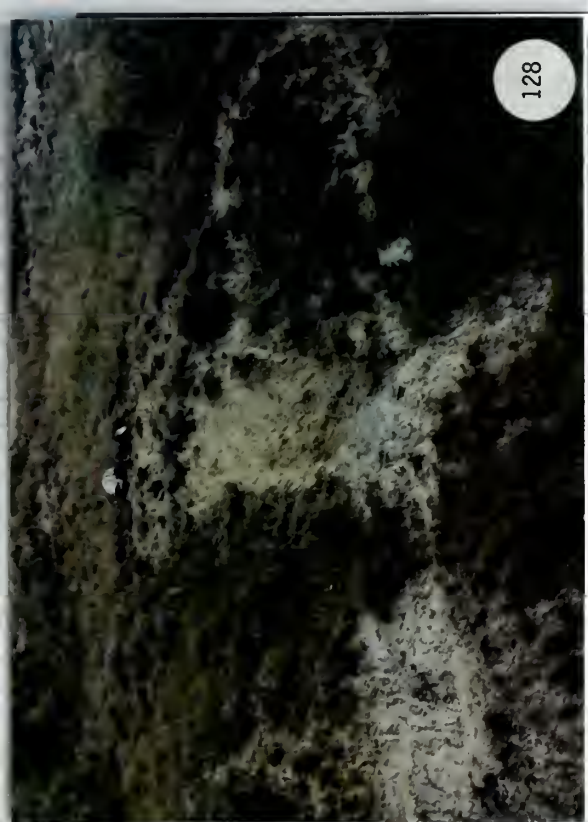Before, during and after construction photographs.
Photo descriptions are found in the final report.
Construction period: 9/9/93-9/26/93

